

#### RESORT MUNICIPALITY OF WHISTLER

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### Non-Delegated Development Variance Permit No. DVP01223

To: SYER, TOMMY M LITTLE, TAMARA M

"the Permittee"

- 1. This Development Variance Permit is issued by the Resort Municipality of Whistler (the Municipality) subject to compliance with all of the bylaws of the Municipality applicable thereto, except as specifically varied by this permit.
- 2. This Development Variance Permit applies to and only to those lands within the Municipality described below (except as otherwise provided herein):

PID: 008-744-653

LOT 30 DISTRICT LOT 7251 PLAN 13066

"the lands"

- 3. The Resort Municipality of Whistler Zoning and Parking Bylaw No. 303, 2015 is varied as follows:
  - a) Vary Part 5 Section 35 Subsection (15), to permit a minimum of two parking spaces on a parcel, without the provision of one parking space per dwelling unit;
  - b) Vary the front setback from 7.6 metres to 1.92 metres for an auxiliary building for auxiliary residential dwelling unit use;
  - c) Vary the front setback from 7.6 metres to 3.7 metres and vary the (south) side setback from 3 metres to 0.96 metres for three auxiliary buildings for bike storage use:
  - d) Vary the rear setback from 7.6 metres to 2.47 metres for a detached dwelling; and
  - e) Vary the (south) side setback from 3 metres to 1.34 metres for a landscape stair roof support post;

all as illustrated on the Architectural Plans A001, A004, A005, A006, A007, A104, A105,



A106, A108, A201, A202, A203, A302 and A303 prepared by GNAR Inc, dated September 10, 2025 attached to this Development Variance Permit as Schedule A.

- 4. The development shall be constructed on the lands in accordance with the following terms and conditions:
  - a) Six (6) covered and secure bike parking spaces with electric charging facilities shall be provided on the parcel in the form of three (3) double capacity CycleSafe ProPark Standard Model SM-S01 units per Pages 3, 6, 7, 9 and 11, attached to this Development Variance Permit as Schedule B (or similar) and shall be installed as illustrated on Architectural Plan A005, prepared by GNAR Inc, dated September 10, 2025 attached to this Development Variance Permit as Schedule A.
- 5. This Development Variance Permit shall automatically lapse, and the Municipality may file a notice of cancellation of this Development Variance Permit with the registrar of the Land Title Office if the Permittee does not substantially commence the construction permitted by this Development Variance Permit within two (2) years of the date of issuance.
- 6. The lands shall be developed strictly in accordance with the terms and conditions and provisions of this Development Variance Permit and any plans and specifications attached to this Development Variance Permit which shall form a part hereof.
- 7. The terms of this Development Variance Permit, or any amendment to it, are binding on all persons who acquire an interest in the lands affected by this Development Variance Permit.
- 8. This Development Variance Permit <u>is not</u> a Building Permit. A Building Permit is required for buildings, structures and site work regulated by the Municipality's building regulation bylaw, in addition to this Development Variance Permit.


Authorizing	resolution passe	d by the Council the	day of	, 2025.
Issued this	day of	, 2025.		

Delegated approval by Mr. Dale Mikkelson, General Manager of Climate Action, Planning and Development Services.





Dale Mikkelson, General Manager of Climate Action, Planning and Development Services



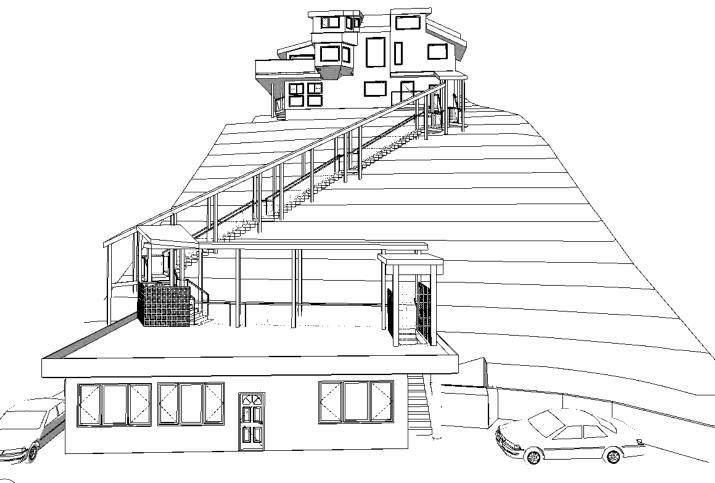

3D Architectural Perspective B&W

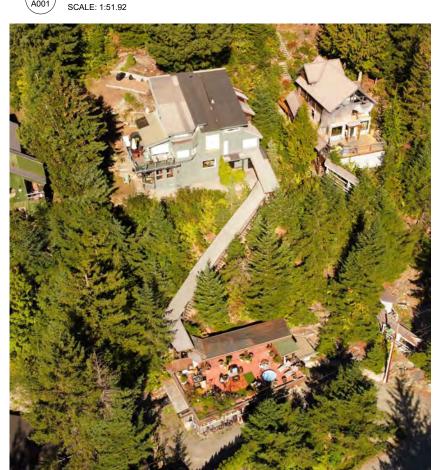

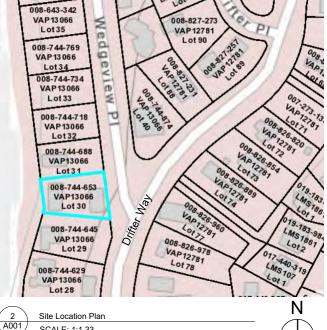

SCALE: 1:1.33

Aerial photo of existing site showing site conditions, siting and slope etc

#### **Project Team**

GNAR Inc.

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Bunbury & Associates Land Surveying Ltd.

Phone: +1 604 892 3090

jeremy@bunbury-surveys.com Fmail:

Contact: Jeremy Childs

#### **Property Information**

Project Type: Renovation / Addition / Legitimization - BP Application

Owners: Tom Sver and Tamara Little

Site Address: 8576 Drifter Way Whistler BC

Legal Description: Lot 30 District Lot 7251 Plan 13066

Parcel Identifier: 008-744-653

Zoning: RI1

Setbacks: Side 3 m, Rear 7.6 m, Front 7.6 m (See variances below)

Building Height: Proposed = 8.1m; Max permitted = 7.6 m (see variances)

Lot Area: 965.1 sqm

Site Coverage Ratio = 160.12 sqm / 965.1 sqm = 16.59%

Gross Floor Area = 325.04 sqm

Floor Space Ratio = 325.04 sqm / 965.1 sqm = 33.68%

## Development Variance Permit List of Variances Requested: (Refer to Appendix A006 for photographs of requested variance areas):

Parking:

1: Reduce the amount of required on-site parking spaces from three to two. Auxillary Residential Dwelling:

2: Vary the front setback (East) from 7.6m to 1.92m for the existing auxiliary

residential dwelling as shown on Bunbury survey plan dated 8 June 2022. Auxillary Bike Storage Units:

3: Vary the front setback (East) from 7.6m to 3.7m for three new auxiliary bike storage units, and to vary the side setback (South) from 3m to 0.96m for two auxiliary bike storage units.

Detached Main Dwelling:

4: Vary the rear setback (West) from 7.6m to 2.47m for the detached dwelling as shown on Bunbury survey plan dated 8 June 2022. (Variance includes detached dwelling, roof support posts, deck and stairs)

Landscape Stairs: 5: Vary the side setback (South) from 3m to 1.34m for the existing access landscape

stairs roof post, as shown on Bunbury survey plan dated 8 June 2022. Parking:

6: Reduce the parking setback from 1.5m to 0m from the front parcel line for both parking spaces.

7: Reduce the parking setback from 1.5m to 0.5m from the side parcel line for parking space 2.

#### Detached Main Dwelling:

8: Vary the side setback (South) from 3m to 2.61m for the existing main building deck foundations and posts as shown on Bunbury survey plan dated 8 June 2022.

9: Vary the maximum required roof height for the existing as built main dwelling roof from 7.6m from average lowest finished grade by 0.5m to 8.1m due to awkward slope of existing siting

Variances 1-5 are non-delegated, variances 6-9 are delegated

General Notes

1. All work shall conform to Part 9 of the BC Building Code 2024 Major Occupancy C and all other applicable codes and ordinances.

2. Do not scale drawings: use calculated dimensions only. Verify existing "as-built dimensions as reg'd. All dimensions are to face of stud unless noted otherwise.

3. Verify all rough-in dimensions and locations for equipment, fixtures etc. Provide all blocking, buck-outs, backing and jacks required for installation

4. All wood in contact with concrete to be pressure treated

5. All flashing to be galvanized, galvalume or factory finish to be approved by architect and owner

6. Contractor shall verify all existing conditions prior to initiating any portion of the

7. Provide all protection, shoring and bracing as required by site conditions in order to maintain a safe job site and protect components to remain

8. Stair and guardrail openings to be less than 4"

9. Tight line all affected drainage to approved drainage system

10. All framing to be properly caulked, sealed, gasketed or otherwise treated to minimize air infiltration prior to sheathing and finishing.

11. All (new) smoke detectors to be hardwired to home's electrical system

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A003 Site and Service Plan - Demolition

A004 Site and Service Plan - Proposed A005 Site Plan with Variances

A006 Appendix for Site Plan with Variances

A007 Site Section

A008 Aerial Photo

A009 Wildfire DPA Guideline Plan

A010 GFA and Roof Height Calculation

A011 Spatial Separation Calculation

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A102 Demolition Plans

A103 Foundation Plan

A104 Lower Level Suite Plan

A105 Main Level Plan A106 Upper Level Plan

A107 Roof Plan

A108 Auxiliary Suite Plan

A109 Auxiliary Suite Roof Plan

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A202 Elevations Main Dwelling A203 Elevations Auxiliary Suite

Sections

A301 Site Section SS

A302 Sections Main Dwelling

A303 Sections Auxiliary Suite

## All work to be completed in tandem with code consultant review\*

To be submitted under Small-Scale Multi-Unit Housing (SSMUH) 1. Demolish roof deck use above garden suite, return to roof only

2. Install conforming guardrail to restrict further access to roof

3. Demolish multiple non-conforming shed structures throughout 4. Install conforming handrail on access stairs where required.

5. Provide adequate clear headroom on access stairs. Install slip resistant nosings or other stair applications on access stairs.

6. Legitimize existing non-permitted floor area.

7. Install/verify/repair fire separation of as-built suites 8. Install conforming lighting on access stairs.

9. Renovate kitchen & main bathroom as per drawings.

10. Replace inoperable smoke alarms throughout.

11. Existing operable windows are recommended to have window opening restrictors installed so that the window opening will not exceed 100mm in width.

12. Demolish storage walls to reduce overall GFA to what is permitted by

zoning.

13. Resolve any other non-conforming items identified on site in collaboration with the Code Consultant and RMOW



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tom\_syer@hotmail.com PROJECT: H69 - 8576 Drifter Way

8576 Drifter Way Whistler BC This Drawing Set is to be submitted as part of Development Variance Permit 1223 - DVP01223 is applied for in tandem with BP6540/6541 to bring as-built existing non-conforming construction into compliance with BCBC2024 and

Zoning and Parking Bylaw 303. Drawing size is 22"x34" Prints on 11"x17" are at 50% scale

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ISSUE:

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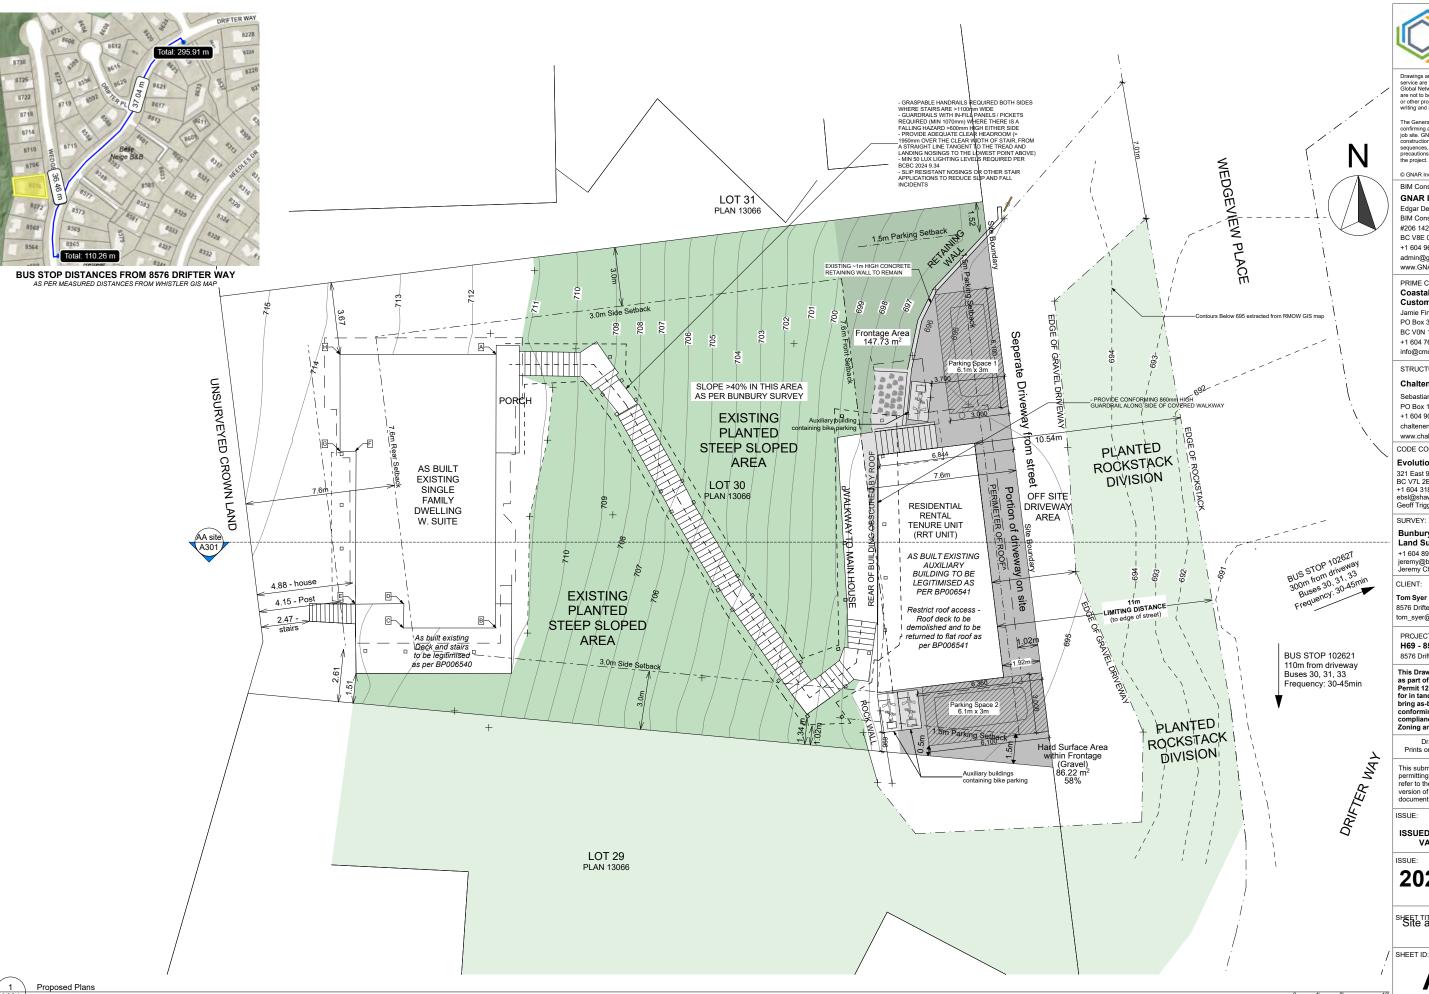
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Cover Sheet and Site

Location Plan

A001

# Scope of Work For Build Permits 006540/006541:





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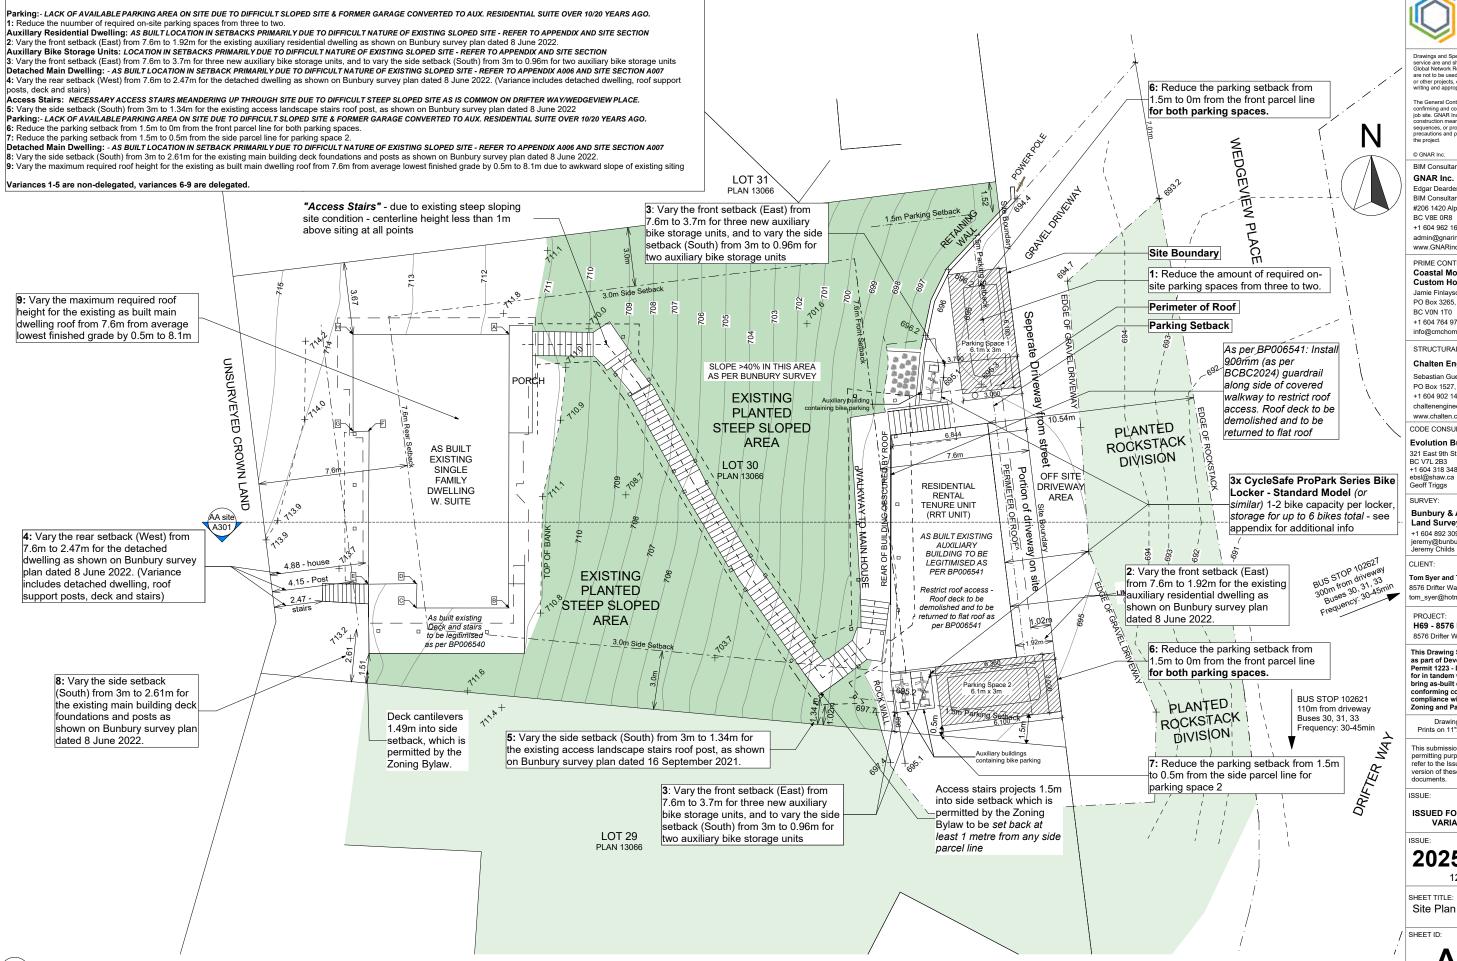
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SHEET TITLE: Service Plan -Proposed



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Site Plan with Variances

A005

Development Variance Permit List of Variances Requested: (Refer to Appendix A006 for photographs of requested variance areas):

- 1: Reduce the amount of required on-site parking spaces from three to two.

  6: Reduce the parking setback from 1.5m to 0m from the front parcel line for both parking spaces. 7: Reduce the parking setback from 1.5m to 0.5m from the side parcel line for parking space 2. Auxilliary Residential Dwelling:
- 2: Vary the front setback (East) from 7.6m to 1.92m for the existing auxiliary residential dwelling as shown on Bunbury survey plan dated 8 June 2022. Auxillary Bike Storage Units:
- 3: Vary the front setback (East) from 7.6m to 3.7m for three new auxiliary bike storage units, and to vary the side setback (South) from 3m to 0.96m for two auxiliary bike storage units.













4: Vary the rear setback (West) from 7.6m to 2.47m for the detached dwelling as shown on Bunbury survey plan dated 8 June 2022.

(Variance includes detached dwelling, roof support posts, deck and stairs)

8: Vary the side setback (South) from 3m to 2.61m for the existing main building deck foundations and posts as shown on Bunbury survey

9: Vary the maximum required roof height for the existing as built main dwelling roof from 7.6m from average lowest finished grade by 0.5m to 8.1m due to awkward slope of existing siting - refer to DVP-A07 - Site Section





SCHEDULE A









f) steep sloping front of site







5: Vary the side setback (South) from 3m to 1.34m for the existing access landscape stairs roof post, as shown on Bunbury survey plan dated 8 June 2022.













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Appendix for Site Plan with Variances

#### Development Variance Permit List of Variances Requested: (Refer to Appendix A006 for photographs of requested variance areas):

Parking: LACK OF AVAILABLE PARKING AREA ON SITE DUE TO DIFFICULT SLOPED SITE & FORMER GARAGE CONVERTED TO AUX. RESIDENTIAL SUITE OVER 10/20 YEARS AGO. 1: Reduce the nuumber of required on-site parking spaces from three to two.

Auxillary Residential Dwelling: AS BUILT LOCATION IN SETBACKS PRIMARILY DUE TO DIFFICULT NATURE OF EXISTING SLOPED SITE - REFER TO APPENDIX AND SITE SECTION

2: Vary the front setback (East) from 7.6m to 1.92m for the existing auxiliary residential dwelling as shown on Bunbury survey plan dated 8 June 2022.

Auxillary Bike Storage Units: LOCATION IN SETBACKS PRIMARILY DUE TO DIFFICULT NATURE OF EXISTING SLOPED SITE - REFER TO APPENDIX AND SITE SECTION

3: Vary the front setback (East) from 7.6m to 3.7m for three new auxiliary bike storage units, and to vary the side setback (South) from 3m to 0.96m for two auxiliary bike storage units Detached Main Dwelling: - AS BUILT LOCATION IN SETBACK PRIMARILY DUE TO DIFFICULT NATURE OF EXISTING SLOPED SITE - REFER TO APPENDIX A006 AND SITE SECTION A007 4: Vary the rear setback (West) from 7.6m to 2.47m for the detached dwelling as shown on Bunbury survey plan dated 8 June 2022. (Variance includes detached dwelling, roof support

Access Stairs: NECESSARY ACCESS STAIRS MEANDERING UP THROUGH SITE DUE TO DIFFICULT STEEP SLOPED SITE AS IS COMMON ON DRIFTER WAY/WEDGEVIEW PLACE.


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Parking:- LACK OF AVAILABLE PARKING AREA ON SITE DUE TO DIFFICULT SLOPED SITE & FORMER GARAGE CONVERTED TO AUX. RESIDENTIAL SUITE OVER 10/20 YEARS AGO.

6: Reduce the parking setback from 1.5m to 0m from the front parcel line for both parking spaces. 7: Reduce the parking setback from 1.5m to 0.5m from the side parcel line for parking space 2.

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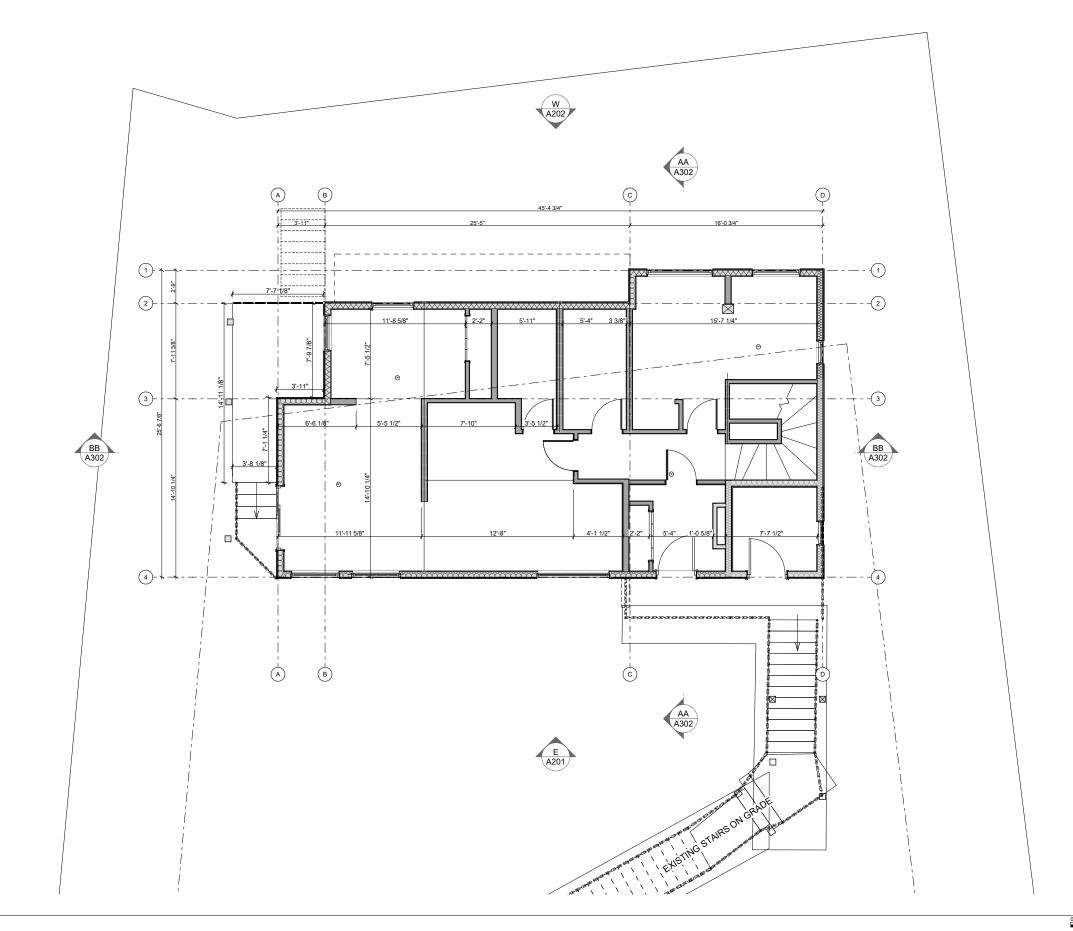
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Site Section



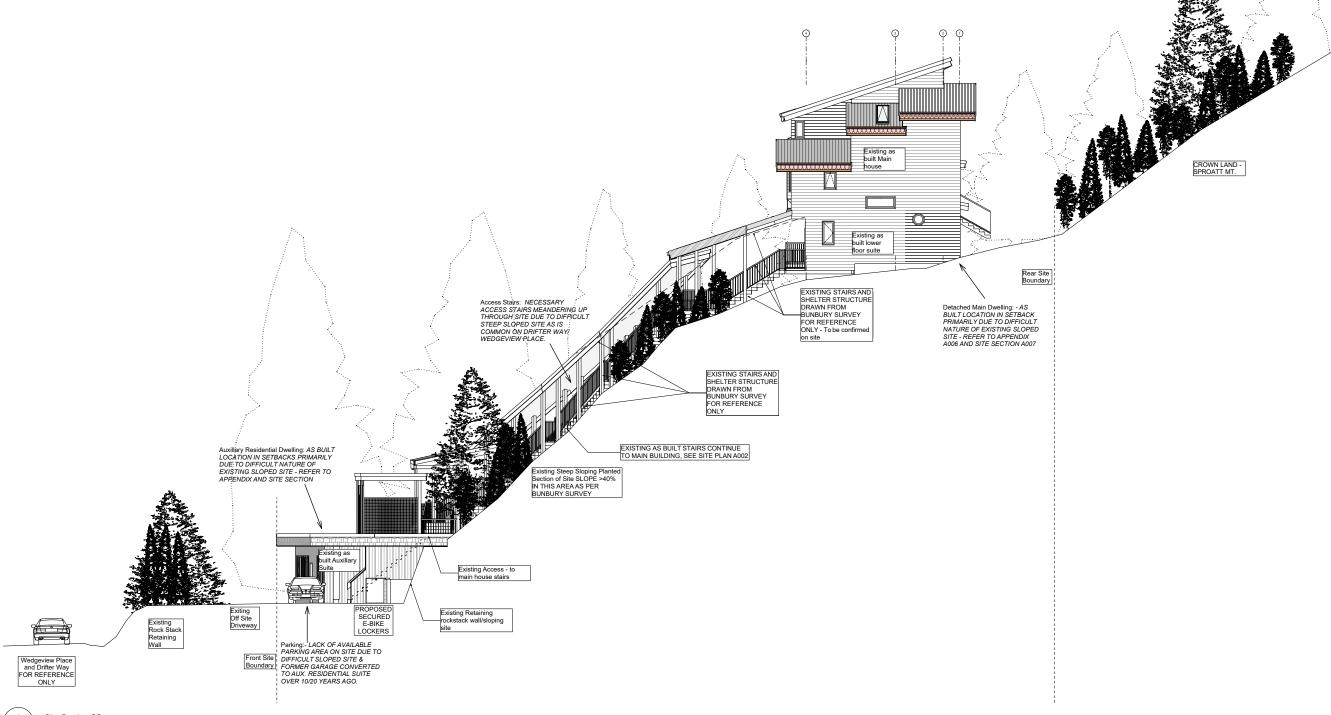

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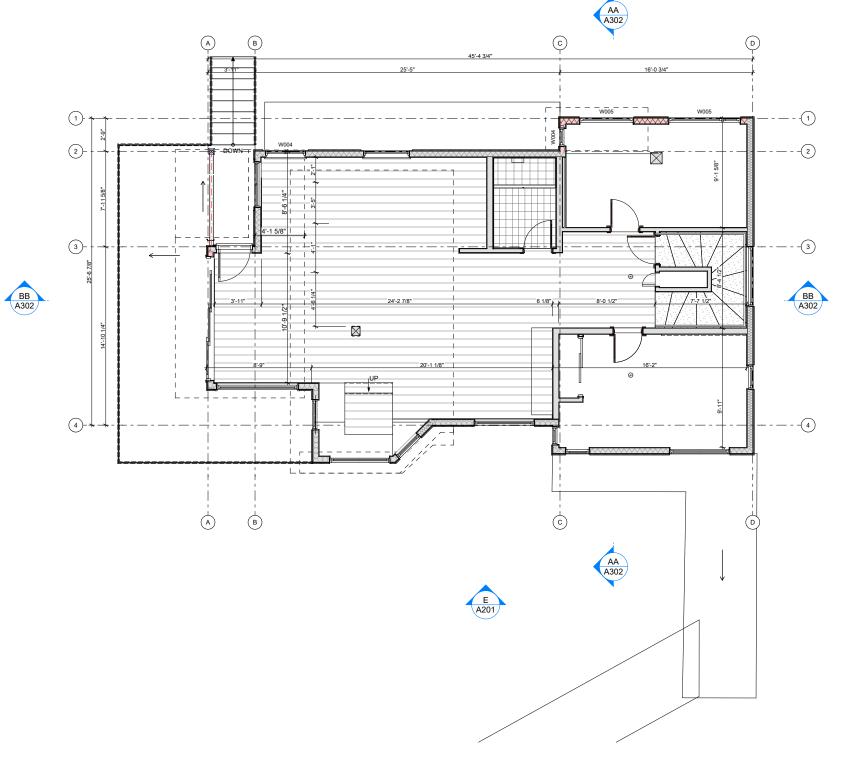
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2025-09-10 12:30 PM

SHEET TITLE:

Lower Level Suite Plan









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PROJECT: H69 - 8576 Drifter Way

8576 Drifter Way Whistler BC

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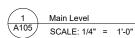
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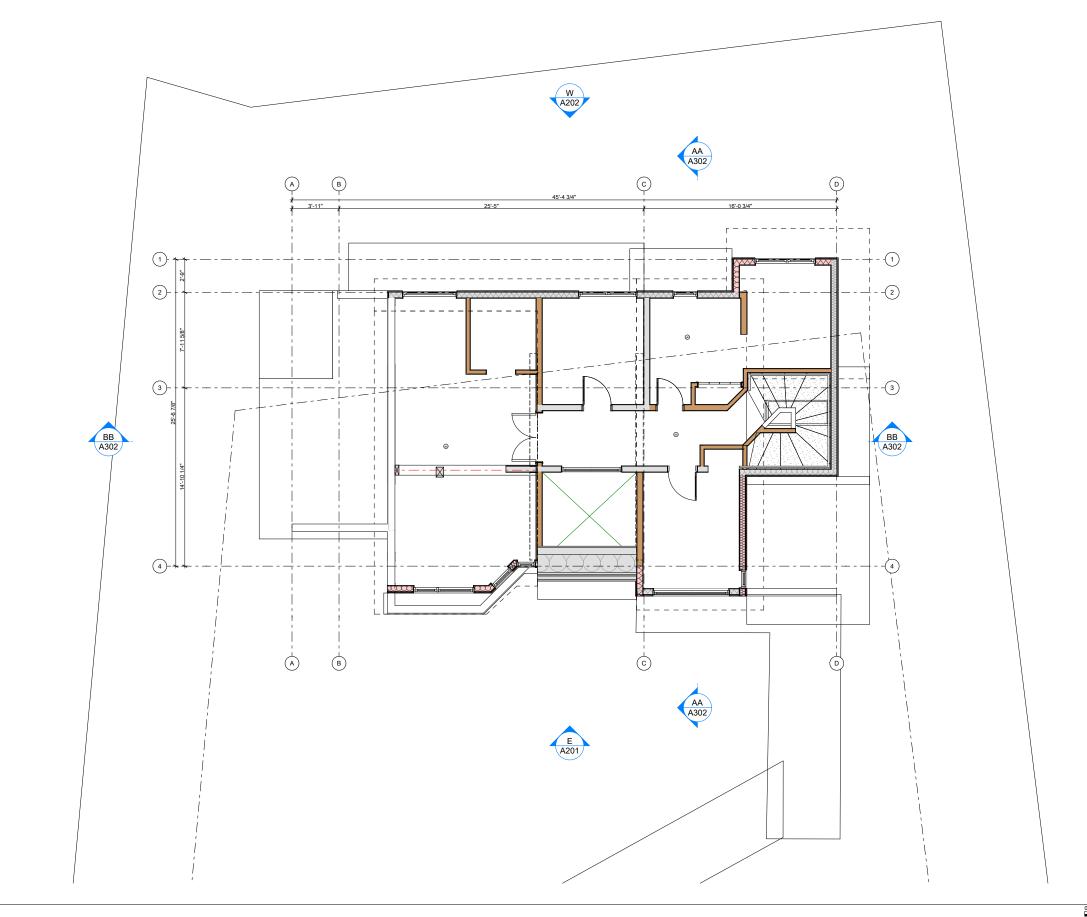
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SHEET TITLE:

Main Level Plan







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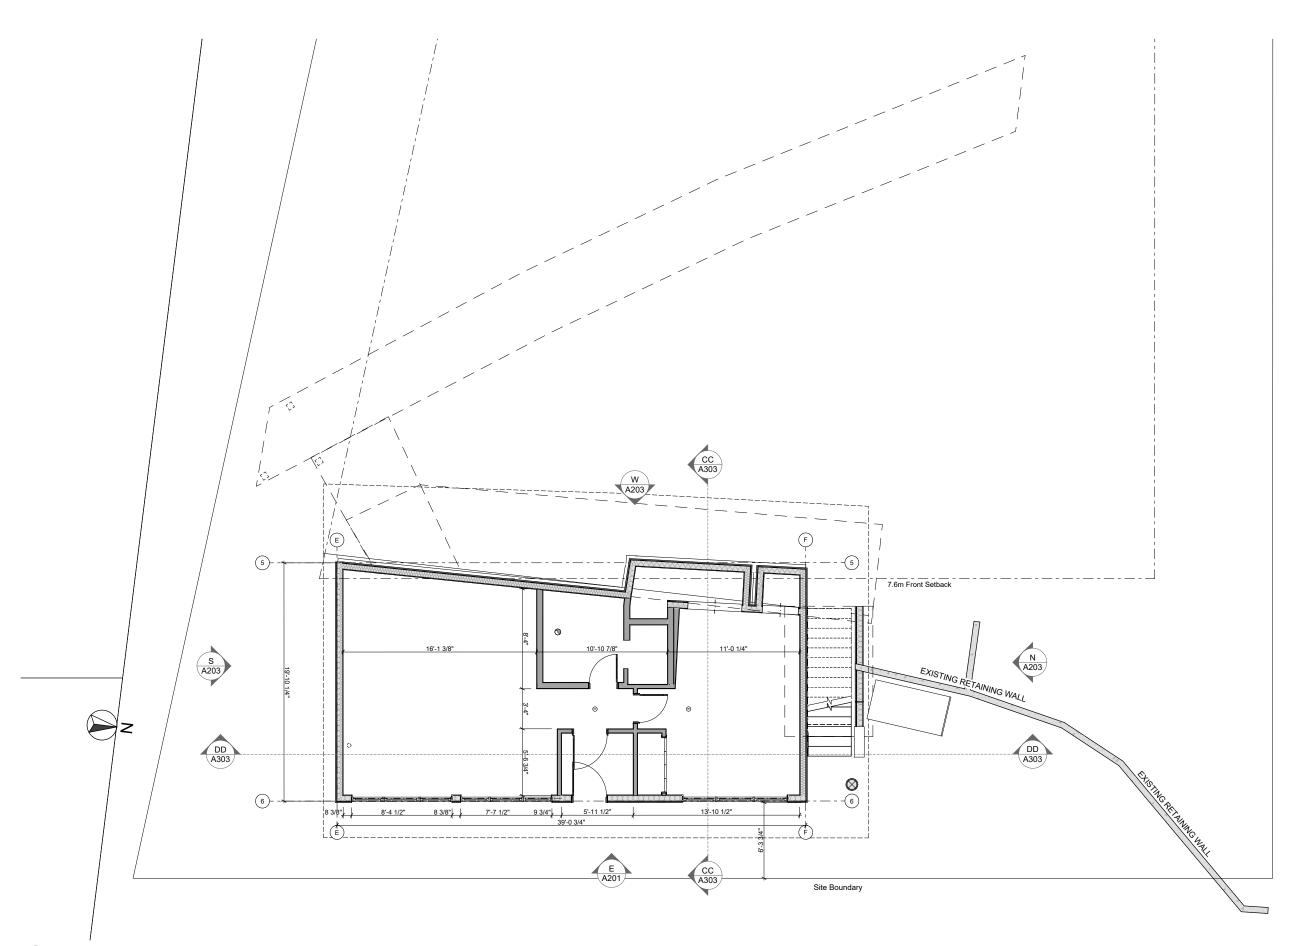
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SHEET TITLE:

Upper Level Plan



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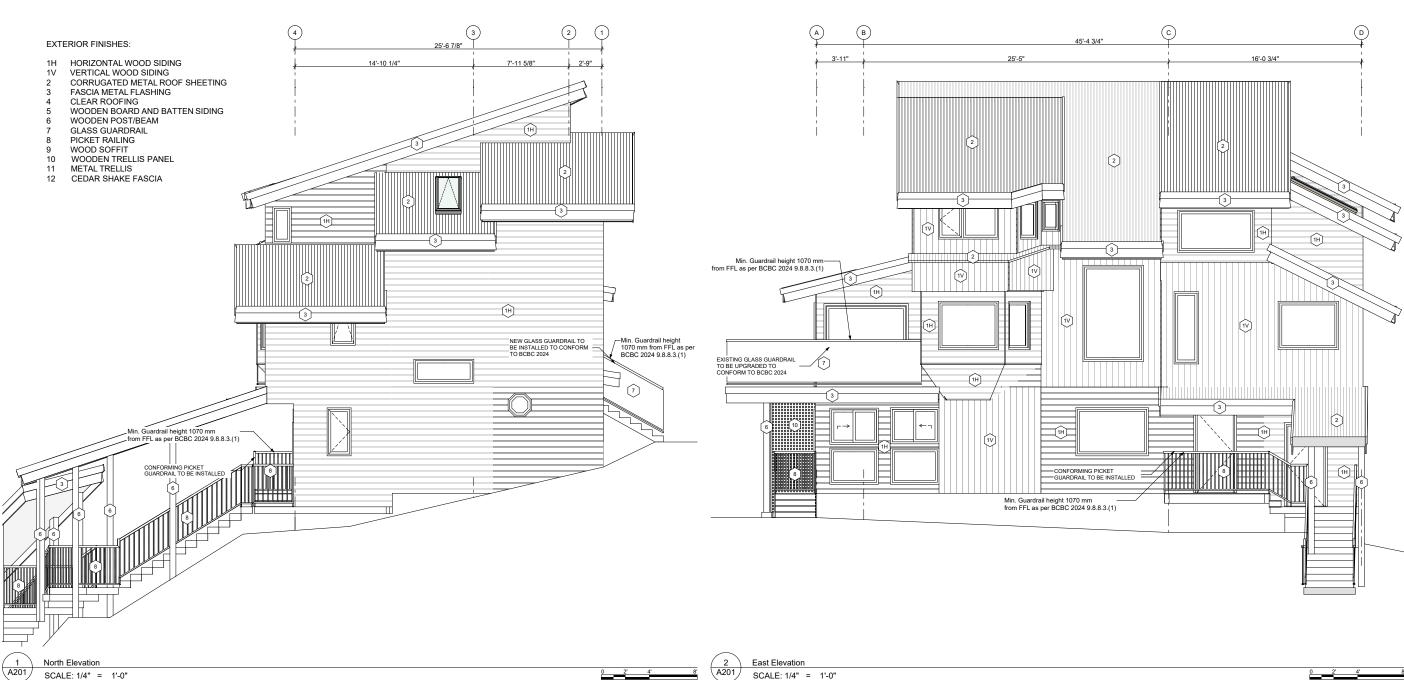
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SHEET TITLE:
Auxiliary Suite Plan





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PROJECT:

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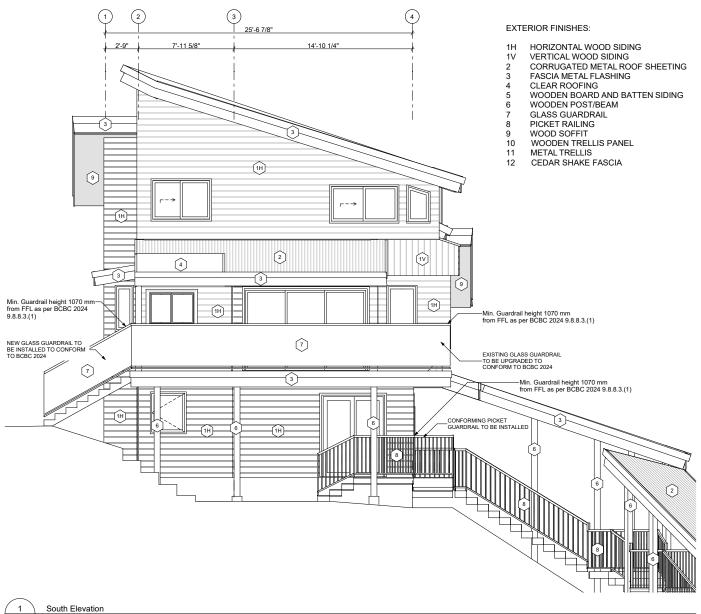
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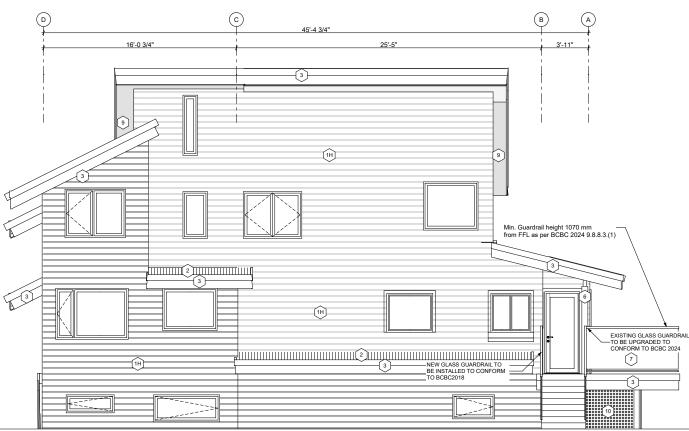
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SHEET TITLE:

Elevations Main Dwelling



SCALE: 1/4" = 1'-0"



West Elevation SCALE: 1/4" = 1'-0"

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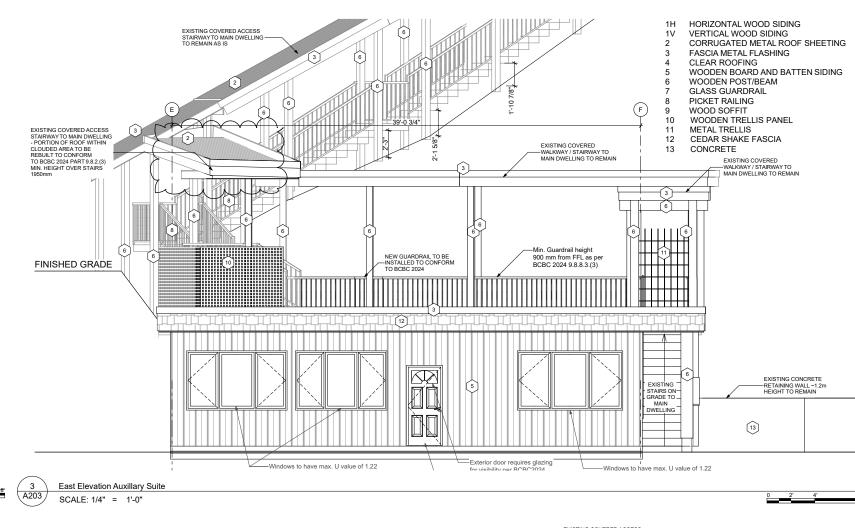
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2025-09-10

12:30 PM

SHEET TITLE: Elevations Main Dwelling

### SCHEDULE A



SCALE: 1/4" = 1'-0" EXISTING COVERED ACCESS STAIRWAY TO MAIN DWELLING - PORTION OF ROOF WITHIN CLOUDED AREA TO BE REBUILT TO CONFORM (6) 19'-10 1/4" EXISTING COVERED ACCESS
-STAIRWAYTO MAIN DWELLING
TO REMAIN AS IS Min. Guardrail height 900 mm from FFL as pe BCBC 2024 9.8.8.3.(3) (12)

EXISTING COVERED ACCESS STAIRWAYTO MAIN DWELLING - PORTION OF ROOF WITHIN CLOUDED AREA TO BE REBUILTTO CONFORM TO BCBC 2024 PART 9.8.2.(3) MIN. HEIGHT OVER STAIRS 1950mm

19'-10 1/4"

Min. Guardrail height 900 m from FFL as per BBBCBC 2024 9.8.8.3.(3)

rom FFL as per BCBC 2024 9.8.8.3.(3)

13

North Elevation Auxillary Suite

South Elevation Auxillary Suite

SCALE: 1/4" = 1'-0"

A203

EXISTING COVERED ACCESS STAIRWAYTO MAIN DWELLING - PORTION OF ROOF WITHIN CLOUDED AREA TO BE REBUILT TO CONFORM TO BCBC 2024 PARTS 8.2.(3) MIN. HEIGHT OVER STAIRS 1950mm 39'-0 3/4" NEW GUARDRAIL TO BE INSTALLED TO CONFORM TO BCBC 2024

4 A203

East Elevation Auxillary Suite

SCALE: 1/4" = 1'-0"

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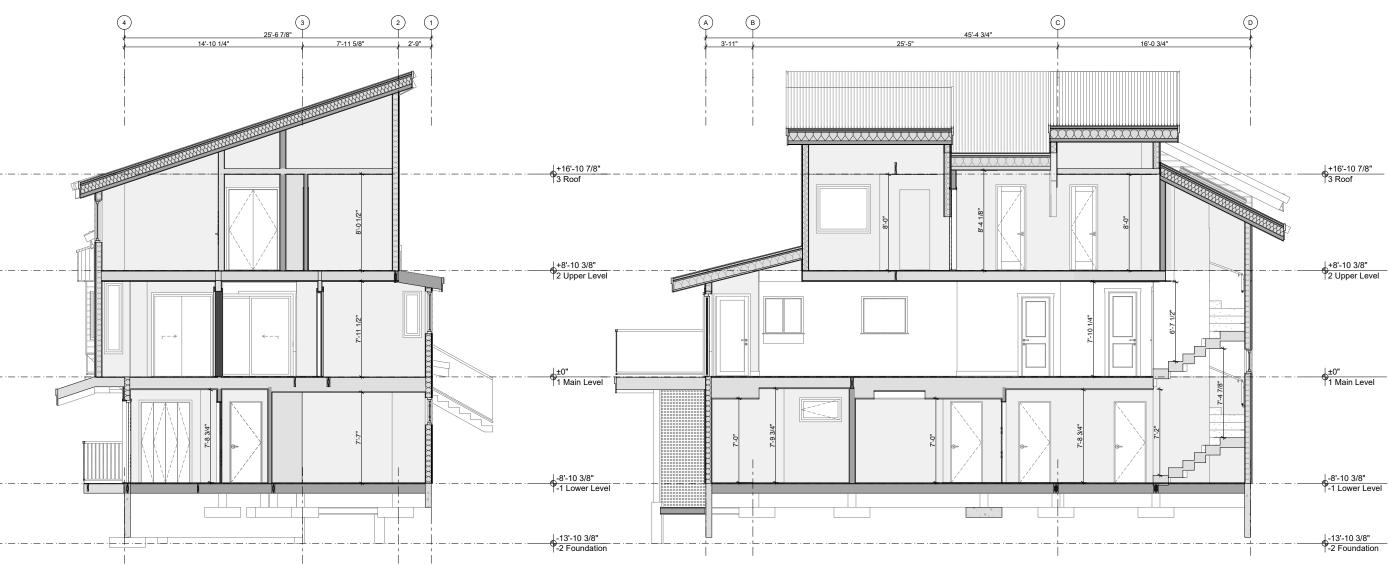
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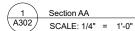
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2025-09-10 12:31 PM

SHEET TITLE:

Elevations Auxiliary Suite







Section BB SCALE: 1/4" = 1'-0"

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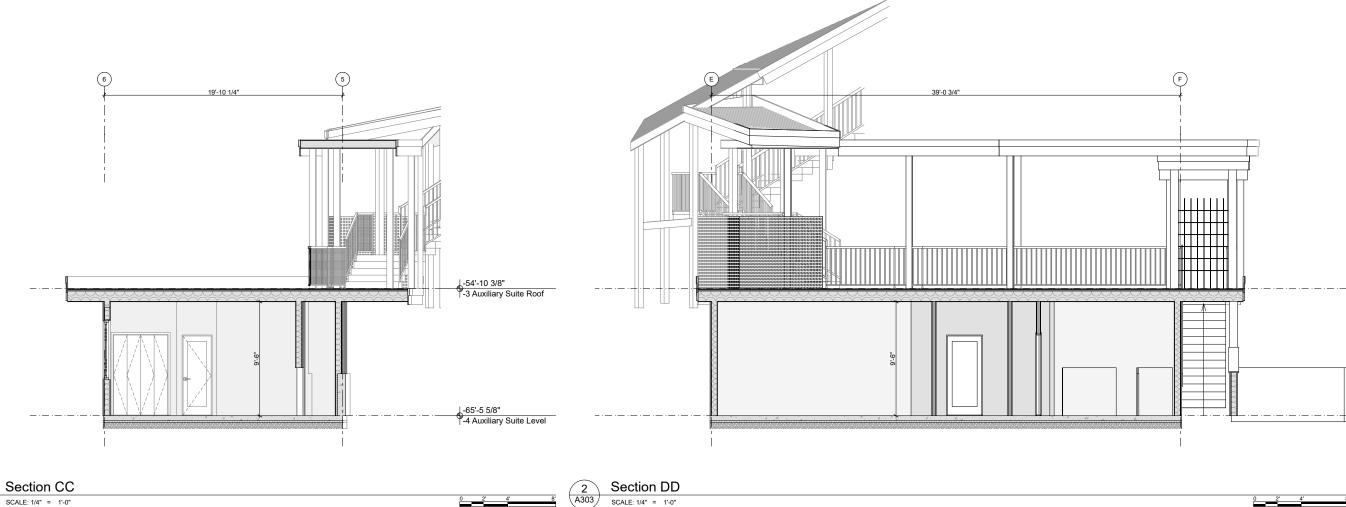
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2025-09-10

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SHEET TITLE: Sections Main Dwelling

Issued as part of BP application which is to coordinate with this DVP application



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2025-09-10

12:31 PM SHEET TITLE:

Sections Auxiliary Suite

## **Versatile System Solutions**

The bicycle locker pioneer: CycleSafe lockers are engineered with high strength poly-resin composites with the high impact resistance of structural steel. The benchmark in secure bicycle parking, CycleSafe offers the most secure, versatile and cost effective bicycle locker to outperform and outlast the competition.

Our quality manufacturing standards produce a rigid structure that ships knocked down in kit form for ease of assembly for reduced freight, or preassembled and shipped upon request.

## **Product Overview**

The ProPark® series by CycleSafe is a modular, interlocking locker system that stores bikes and gear in a weatherproof, fire-retardant, vandal-deterrent structure.

A standard unit has a door on each side with a diagonal interior partition, creating two triangular stalls to stow bikes horizontally with handlebars near the door. This modular system can be configured to meet any site's specifications, designed to be flexible, to accommodate future expansion. Models and features may include:

- Single-Sided Access (limited access)
- Double-Sided Access (standard model)
- CycleSafe Electronic Access Door (long term/short term keyless entry)
- Double-Tier Locker (high capacity)
- Display Side Panels (marketing and communications)
- Storage Bins (cyclists gear)

## Setting the Standard for Secure Bicycle Parking

- Awarded the first bicycle storage patent issued in the U.S.
- Industry's most durable locker, with a 30-plus year proven product life
- Selected by more North American transit agencies, corporations, and institutions than any other cycle storage unit
- Five-year limited warranty
- Manufactured to ISO 9001 and 14000 international quality
- Contributes to LEED certification
- · Made in the USA






At a transit hub, on campus, or at the office, CycleSafe lockers promote community health and fitness.

## Structural Options

Standard Model SM/M02 2 Bike Capacity



Standard Model SM/M10

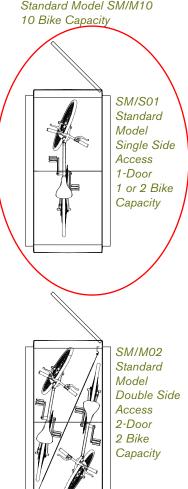

Since facility needs and requirements vary, CycleSafe offers a full range of models, upgrades, and accessories for our locker system.

## Standard Model (SM)

The industry standard for bicycle commuters, this system accommodates two bicycles, one per door. This Standard model is the basis for all the CycleSafe models and supports the Security and Quality claims. Units are modular and may be expanded or upgraded to accommodate site or program requirements.

## Door-View Model (DV)

The Door View model provides managers the ability to monitor locker contents or usage without allowing a full public view. It features a framed 11" x 11" polycarbonate window in the door.

## Side-View Model (SV)

The end panels on the Side View model have weatherproof, shatterproof polycarbonate inserts 23" x 60" that make the locker contents instantly visible for security purposes - and for locating an available locker. A polycarbonate interior partition allows a clear view through a row of lockers. Perforated metal or other architectural materials may be specified.

## View-Thru Model (VT)

This model offers full view thru, combining a window in the door, end panels and interior partitions to allow full public view of contents and locker availability. Polycarbonate is the standard material for viewing, perforated metal inserts can be substituted for minimizing visibility.

## Double-Tier Model (DT)

The Double Tier model offers maximum space efficiency to double the bike parking capacity by stacking a second locker on top of a lower locker. Similar to lifting a bike on a car roof rack, twice as many lockers can be added without increasing the footprint. The lock mechanism is located at the base of the upper door for easy access. A door check holdback mechanism props the door open for ease of entry. A retrofit kit is available to add double tier units to existing locations. Double Tier units measure approximately 101" in height, and can be specified with Door View windows.



DV/M02



SV/M02



VT/M02



DT/M04

## Single-Side Access Option

If your site plan requires lockers to be placed against a wall due to limited space, choose the Single Sided Access option. Each locker provides parking for one or two bikes, with a fixed rear panel with no interior partition. This model can also be specified with or without windows for viewing contents or locker availability. See chart on page 11 for ordering details.



SM/S01 Single-Sided Access Option

## Display Panel Options

CycleSafe's display end panels give users unlimited options for integrated communications or architectural enhancements.

• **Communications:** The recessed portion of the end panel (24" x 60") allows you to incorporate promotional messages, including custom logos and transit maps, or to sell revenue-generating ad space. Our most popular design incorporates an aluminum poster grip frame, making it easier to interchange promotional formats. Other display formats include adhesive labels, backlit panels, and programmable LED displays.



SM/M06 with Wayfinding panel



SM/M08 with Promotional panel

## Interior Partition Options

The standard interior partition is made of SMC or Poly resin composite 3/16th thickness. Other available options include: coated metal partitions or clear polycarbonate.



Interior partition

## Smartloc<sup>™</sup> CycleSafe Keyless Access

This CycleSafe Smartloc design provides cyclists user access to lockers with a plethora of benefits.

Smartloc Electronic Access facility manager Benefits:

- Administrative monitoring & reporting
- Revenue generating via hourly, daily, or even monthly use rentals.
- Further revenue opportunities through bike or personal mobility device rentals.
- Automated credit/debit card billing directly to the end user.
- Increased locker occupancy rates by enabling multi-user access to each locker.
- Identify and track users through online membership database.
- Eliminates need for management of door key distribution and locker assignment.

Smartloc Electronic Access end user Benefits:

- · Keyless access, on demand use.
- Safe secure and flexible program for parking bikes.
- 24/7 online availability and reservation capabilities.
- Unique key code combinations for each access event.
- Convenient & inexpensive means to protect your valuable bicycle transportation.

For further information contact info@cyclesafe.com or your local representative for detals.

## Accessories

# Outfit your lockers with any number of special features based on site/user demands. Options include:



#10635 Door check/holdback kit for propping door open, allowing unrestricted access



#10790 Coat hook, partition mounted, for hanging personal items – (2 double hooks per order)



#10768 Door mounted 4-1/2" x 5" stainless steel louvered vent to reduce heat, mold, mildew in extreme climates.



#19901 - 24" x 60" #19905 - 44" x 72" PosterGrip® snap-in aluminum frame for displaying ads, maps, etc. on display end panel:




#10789 Door-mounted storage bin for non-View Thru models only



#15800 Power Center – GFI electrical outlet for charging Electric Bikes or other accessories



#10689 Aluminum mounting plate. #10755 Interior door brace for asphalt/non-concrete surface

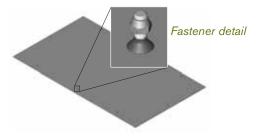

# 10670 Floor panel, for SM/02




#10709 Bicycle parking decals

## Available by special order

- Solar panel kit for electric bike charging station
- #10020 CycleManager® CD-ROM for locker program administration

## CycleSafe ProPark Series Bicycle Locker Layout

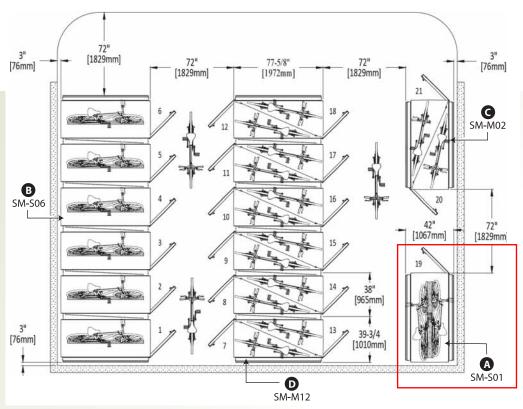

CycleSafe
ProPark Series
Locker Clearance
& Capacities

- A SM-S01 one door access for 1-2 bikes
- B SM-S06 one door access for 6 bikes
- **G** SM-M02 two door access for 2 bikes
- SM-M12 two door access for 12 bikes

#### Also available:

DT/SM-M04 – double tier 4 door access for 4 bikes (not shown) DT/SM-S02 – two door single access for 2 bikes (not shown)

**SM** = Standard Model, Two Door

**DV** = View Thru Door

**SV** = Side View

**VT** = View Thru/Full

**DT** = Double Tier

Description

No Windows Windows in Doors

Windows in Sides

## All locker systems are 4'2" high x 6'6" deep x length listed in chart below.

S = Single Side Access (1) Door M = Double Side Access (2) Door

	Part #	Model & Option Description		
	SM-S01	Standard Model + (1) Door = (1/2) Bike Capacity		
	SM-M02	Standard Model + (2) Doors = (2) Bike Capacity		
DV-M02 Door-View + (2) Door Access = (2)Bike Capacity				
	SV-M04 Side-View + (4) Door Access = (4) Bike Capacity			
VT-M06 View-Thru + (6) Door Access = (6) Bike Capacity				
	DT/SM-M24	Double-Tier + (24) Doors = (24) Bike Capacity		

SV-M04	Side-View + (4) Door Access = (4) Bike Capacity					VT	View-	Γhru	Windows	in	Doors & Sid	des	
VT-M06	View-Thru + (6) Door Access = (6) Bike Capacity					DT	Double-Tier Stacked Lockers			kers & Spac	ers		
DT/SM-M24	M24 Double-Tier + (24) Doors = (24) Bike Capacity					M02 Loc	ker Dims are	50-1/2" O	AH x 42" O	١W	x 77-5/8" (	OAL	
Part	(2) Door Model / Number of Bicycles Shi		Shipping	g Weight	Part Model Shi		Shipping	ng Weight Row		Row L	Lengt		
Number	SM	DV	SV	VT	LB	KG	Number	DT/	LB	KG		IN	С
M02	02	02	02	02	450	204	M04	04	912	414		43	1
M04	04	04	04	04	760	345	M08	08	1544	700		81	2
M06	06	06	06	06	1120	508	M12	12	2276	1032		119	3
M08	08	08	08	08	1350	612	M16	16	2748	1246		157	3

Number	SM	DV	SV	VT	LB	KG
M02	02	02	02	02	450	204
M04	04	04	04	04	760	345
M06	06	06	06	06	1120	508
M08	08	08	08	08	1350	612
M10	10	10	10	10	1740	789
M12	12	12	12	12	1970	894
M14	14	14	14	14	2280	1034
M16	16	16	16	16	2590	1175
M18	18	18	18	18	2900	1315
M20	20	20	20	20	3310	1501
M22	22	22	22	22	3590	1628
M24	24	24	24	24	3870	1755

Part	(1) Doo	r Option / I	Bicycles	Shipping	g Weight	
Number	SM	DV	SV	VT	LB	KG
S01	01	01	01	01	393	178
S02	02	02	02	02	646	293
S03	03	03	03	03	949	430
S04	04	04	04	04	1122	509
S05	05	05	05	05	1455	660
S06	06	06	06	06	1628	738
S07	07	07	07	07	1881	853
S08	08	08	08	08	2134	968
S09	09	09	09	09	2387	1083
S10	10	10	10	10	2740	1243
S11	11	11	11	11	2963	1344
S12	12	12	12	12	3186	1445

Part	Model	Shipping	g Weight
Number	DT/	LB	KG
M04	04	912	414
M08	08	1544	700
M12	12	2276	1032
M16	16	2748	1246
M20	20	3540	1605
M24	24	4012	1820
M28	28	4644	2106
M32	32	5276	2393
M36	36	5908	2680
M40	40	6740	3057
M44	44	7312	3317
M48	48	7884	3576

Name

Standard

Door-View Side-View

Model

SM

 $\mathsf{D}\mathsf{V}$ 

SV

Part	Model	Shipping	g Weight
Number	DT/	LB	KG
S02	02	798	362
S04	04	1316	596
S06	06	1934	877
S08	08	2292	1040
S10	10	2970	1347
S12	12	3328	1510
S14	14	3846	1745
S16	16	4364	1980
S18	18	4882	2214
S20	20	5600	2540
S22	22	6058	2748
S24	24	6516	2956

Row I	Row Length						
IN	CM						
43	109						
81	206						
119	302						
157	399						
195	495						
233	592						
271	688						
309	785						
347	881						
385	978						
423	1074						
461	1171						
Row Length							

Row Length						
IN	CM					
43	109					
81	206					
119	302					
157	399					
195	495					
233	592					
271	688					
309	785					
347	881					
385	978					
423	1074					
461	1171					