

THE RESORT MUNICIPALITY OF WHISTLER

4325 Blackcomb Way TEL 604 932 5535

Whistler, BC Canada VON 1B4 TF 1 866 932 5535 www.whistler.ca FAX 604 935 8109

DEVELOPMENT VARIANCE PERMIT APPLICATION

Resort Experience, Planning Department Tel 604-935-8170 (direct) Fax 604-935-8188

Email: planning@whistler.ca

Application Number	
DVP	
Work Order	
Received by	
(OFFICE USE ONLY)	

Subject Property Street	t Address: 8576 Drift	er Way		
Legal Description P.I.D.	008-744-653		Lot 30	D.L. 7251
	13066		Block	Zoning RI1
Name of Registered Ov	vner: Tommy Marve	n Syer & Tamar	a Maureen Little	
City:		Province:	Postal Code:	
Phone:	Cell:	Email:		Fax:
Name of Applicant/Age	nt: GNAR Inc			
Mailing Address: Unit 2	06, 1420 Alpha Lake	e Road		
City: Whistler		Province: BC	Postal Code:	V8E0R8
Phone: 604-962-1611	Cell: 778 833 4627	 _{Email:} info@gna	arinc.com	

SUBMITTAL REQUIREMENTS

- □ Application Fee of \$450.00
- Title Search (issued not more than 30 days from the date application is received) OR \$21 Title Search Fee in lieu (per P.I.D.)
- Written description of the proposal, and the specific site characteristics or other unique circumstances for requiring a variance
- Strata authorization on form attached (as may be required)
- One hard copy plus a PDF of scalable and fully dimensioned plans, elevations, sections, as necessary to illustrate the requested variance(s). Clearly identify and label each variance request on the site plan. Scale of 1:200 (minimum) or imperial equivalent. If imperial equivalent any dimensions must be labelled in both imperial and metric.
- Any further information necessary for the processing of this application

Application Fee: \$450.00	Title Search: \$21.00 (per P.I.D.) 🛚 Y 🎦 N
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	AUTHORIZATIONS				
	Tom Syer and Tamara Little	authorize GNAR Inc			
'	(PRINT NAME of registered owner)		authorized to sign the application)		
	,	tion form to the Resort Municipality of Whistler			
	(Civic address of property)ocusig	ned by:	DocuSigned by:		
10/6/2021	3:58 PM PDT	10/4/2021 8:16 PM PDT	9212079EA1A74A6		
	Signature(s) of registered owner(s)	Date			
;	Signature(s) of Signing Officer(s) of	Corporation Corporate Seal(s), if applicable	Date		
!	PROPERTY OWNER'S AGREEI	MENT			
1 1 2	the contents of the application, certify that facts, and concur with the submission of be subject to applicable laws, regulations Zoning and Parking Bylaw No. 303, 201 Resort Municipality of Whistler Zoning application is approved. I understand that a building permit must match the approved.		I have knowledge of these ibed in the application may cort Municipality of Whistler y with all provisions of the oplicable legislation, if this		
10/6/2021	3:58 PM PDT	10/4/2021 8:16 PM PDT			
	Signature of property owEF99D3AEA2FI	Date	9212079EA1A74A6		
 - 	PAYMENT OF FEES Enclosed is the fee for this application. I agree to pay any further costs (e.g., processing fees for professional and clerical staff time, legal and/or consultant fees, advertising expenses and miscellaneous disbursements at cost), which may be determined as this application is reviewed. Prior to the issuance of a development permit for the above noted property, the Resort Municipality of Whistler requires a commitment that all further expenses incurred by the Resort Municipality of Whistler will be paid within 30 days of billing.				
	BILLING DETAILS Name:				
1	Address:				
(City:	Province: Postal Cod	de:		
ļ	Phone: Cell:	Email:			
	Your signature below will stand 3:58 PM PDT	d as your commitment to pay all applicated 10/4/2021 8:16 PM PD			
;	Signature of owner or applicant A2FB400	Date	9212079EA1A74A6		
[DECLARATION		9212079EA1A74A6		
	Tom Syer and Tamara Little	, solemnly declare that			

Personal information is being collected under the authority of the *Local Government Act* for the purpose of processing this application. This information is protected under the privacy provisions of the *Freedom of Information and Protection of Privacy Act*. If you have any questions about the collection of this information, contact the Director of Planning at 604-935-8170, Resort Municipality of Whistler, 4325 Blackcomb Way, Whistler, BC V0N 1B4.

DocuSigned by:

--- EF99D3AEA2FB40D...

10/4/2021 | 8:16 PM PDT

Date

Signature of applicant or agent U

10/6/2021 | 3:58 PM PDT

RATIONALE FOR <u>DELEGATED</u> DEVELOPMENT VARIANCE PERMITS

DESCRIPTION OF DEVELOPMENT AND VARAINCE(S) (Complete for ALL applications)		
Description of proposed		
development		
development		
Specify each proposed variance		
Specify site characteristics and/or		
other unique circumstances for		
requiring variance(s).		
EVALUATION CRITERIA		
(Complete for ALL applications)		
The variance should be consistent		
with the goals, objectives and policies		
in the Official Community Plan and		
any other relevant Council-approved municipal policy documents.		
municipal policy documents.		
2. The variance application should be		
supported by a sound justification		
based on the applicant's inability to reasonably develop the site in an		
efficient and effective manner while		
complying with bylaw requirements,		
or on the provision of a benefit to the		
community or adjacent properties in		
the form of a preferable development		
outcome that is attributable to the variance.		
3. The variance should not defeat the		
express or implicit intent of the bylaw		
requirement or restriction being		
varied.		
4. The variance should not impose any		
additional costs on the Resort		
Municipality such as additional cost to		
provide services to the development site or adjacent properties.		
site of adjacent properties.		
5. The variance should not create or		
exacerbate any risk to public safety.		
6. The variance should enable the		
applicant's development to do one or more of the following:		
a. Complement the streetscape or		
neighbourhood;		
- ·		
b. Work with the topography of the		
site without major site		
preparation or earthworks;		

 c. Maintain or enhance desirable site features such as natural vegetation, trees and rock outcrops; 	
d. Use superior building siting in relation to light access, reducing building energy requirements;	
e. Use superior building siting in relation to the privacy of occupants and neighbours; and	
f. Preserve or enhance views from neighbouring buildings and sites.	
7. The variance should not result in a significant negative impact on the streetscape or neighbourhood and should incorporate mitigation measures to reduce any identified negative impact. Potential negative impacts to be considered include:	
a. Inconsistency of the development with neighbourhood character;	
 b. Increased apparent building bulk as viewed from the street or surrounding neighbourhood; 	
c. Extensive additional site preparation or earthworks;	
 d. Substantial impact on the use or enjoyment of adjacent land such as reduction of sunlight access or privacy or obstruction of views; and 	
e. Impact on services such as roads, utilities and snow clearing operations.	

ADDITIONAL EVALUATION CRITERIA FOR PARTICULAR TYPES OF DELEGATED DVPs. (Complete if relevant to application)		
8. Sign Regulations		
a. A variance of the number, size or location of signs should not result in a significant increase in the total number or sign area of on- site signage or disrupt the aesthetic character of the development or adjacent neighbourhood.		
b. A variance should not adversely impact neighbouring properties, for example by increasing exposure to artificial light.		
9. Off-Street Parking Design Standards		
a. A variance of the design standard for off-street parking spaces should not create or exacerbate any safety hazard related to the operation of motor vehicles or other forms of transportation.		
10. Solid Waste Separation and Storage		
Facility Regulations a. A variance should not be approved without consultation with the operator of the facility and the municipal engineer to ensure operational feasibility.		
b. A variance should not result in an increase in disruptive intermittent noise affecting building occupants or neighbours.		
11. Building Siting Regulations		
a. A variance should not reduce the livability of existing residential units or units in the development. The applicant should demonstrate with appropriate drawings and calculations that the variance would not significantly interfere with privacy or access to sunlight. 12. Building Height Regulations		
 a. The variance application should be supported with drawings and calculations illustrating shadow and view impacts of the proposed variance, including impacts on public spaces such as parks and green spaces. 		
b. The application should be assessed in relation to compatibility with both existing adjacent uses and uses permitted or contemplated by the Zoning Bylaw and the Official Community Plan.		



A001

SCALE: 1:1.33

3D Architectural Perspective B&W SCALE: 1:51.92



Aerial photo of existing site showing site conditions, siting and slope etc

008-643-342 VAP 13 066 008-827-273 Lot35 VAP12781 0 008-744-769 VAP13066 Lot34 008-744-734 VAP 13 066 Lot 33 008-744-718 VAP13066 008-744-688 VAP13066 Lot31 008-744-653 VAP13066 Lot 30 008-744-645 VAP13066 VAP12781 Lot 78 Lot 29 008-744-629 VAP13066 Lot 28 Ν Site Location Plan

Project Team

GNAR Inc.

#206 1420 Alpha Lake Rd. Whistler BC V8E 0R8

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Phone: +1 604 902 1404

chaltenengineering@shaw.ca Contact: Sebastian Guerrero

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Bunbury & Associates Land Surveying Ltd.

Phone: +1 604 892 3090

jeremy@bunbury-surveys.com Fmail:

Contact: Jeremy Childs

Property Information

Project Type: Renovation / Addition / Legitimization - BP Application

Owners: Tom Sver and Tamara Little

Site Address: 8576 Drifter Way Whistler BC

Legal Description: Lot 30 District Lot 7251 Plan 13066

Parcel Identifier: 008-744-653

Zoning: RI1

Setbacks: Side 3 m, Rear 7.6 m, Front 7.6 m (See variances below)

Building Height: Proposed = 8.1m; Max permitted = 7.6 m (see variances)

Lot Area: 965.1 sqm

Site Coverage Ratio = 160.12 sqm / 965.1 sqm = 16.59%

Gross Floor Area = 325.04 sqm

Floor Space Ratio = 325.04 sqm / 965.1 sqm = 33.68%

Development Variance Permit List of Variances Requested: (Refer to Appendix A006 for photographs of requested variance areas):

Parking:

1: Reduce the amount of required on-site parking spaces from three to two. Auxillary Residential Dwelling:

2: Vary the front setback (East) from 7.6m to 1.92m for the existing auxiliary residential dwelling as shown on Bunbury survey plan dated 8 June 2022. Auxillary Bike Storage Units:

3: Vary the front setback (East) from 7.6m to 3.7m for three new auxiliary bike storage units, and to vary the side setback (South) from 3m to 0.96m for two auxiliary bike storage units.

Detached Main Dwelling:

4: Vary the rear setback (West) from 7.6m to 2.47m for the detached dwelling as shown on Bunbury survey plan dated 8 June 2022. (Variance includes detached dwelling, roof support posts, deck and stairs)

Landscape Stairs:

5: Vary the side setback (South) from 3m to 1.34m for the existing access landscape stairs roof post, as shown on Bunbury survey plan dated 8 June 2022. Parking:

6: Reduce the parking setback from 1.5m to 0m from the front parcel line for both parking spaces.

7: Reduce the parking setback from 1.5m to 0.5m from the side parcel line for parking space 2.

Detached Main Dwelling:

8: Vary the side setback (South) from 3m to 2.61m for the existing main building deck foundations and posts as shown on Bunbury survey plan dated 8 June 2022.

9: Vary the maximum required roof height for the existing as built main dwelling roof from 7.6m from average lowest finished grade by 0.5m to 8.1m due to awkward slope of existing siting

Variances 1-5 are non-delegated, variances 6-9 are delegated

General Notes

1. All work shall conform to Part 9 of the BC Building Code 2024 Major Occupancy C and all other applicable codes and ordinances.

2. Do not scale drawings: use calculated dimensions only. Verify existing "as-built dimensions as reg'd. All dimensions are to face of stud unless noted otherwise.

3. Verify all rough-in dimensions and locations for equipment, fixtures etc. Provide all blocking, buck-outs, backing and jacks required for installation

4. All wood in contact with concrete to be pressure treated

5. All flashing to be galvanized, galvalume or factory finish to be approved by architect and owner

6. Contractor shall verify all existing conditions prior to initiating any portion of the

7. Provide all protection, shoring and bracing as required by site conditions in order to maintain a safe job site and protect components to remain

8. Stair and guardrail openings to be less than 4"

9. Tight line all affected drainage to approved drainage system

10. All framing to be properly caulked, sealed, gasketed or otherwise treated to minimize air infiltration prior to sheathing and finishing.

11. All (new) smoke detectors to be hardwired to home's electrical system

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DVP Drawings Set

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A006 Appendix for Site Plan with Variances

A007 Site Section

A008 Aerial Photo

A009 Wildfire DPA Guideline Plan

A010 GFA and Roof Height Calculation

A011 Spatial Separation Calculation

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A102 Demolition Plans

A103 Foundation Plan

A104 Lower Level Suite Plan

A105 Main Level Plan A106 Upper Level Plan

A107 Roof Plan

A108 Auxiliary Suite Plan A109 Auxiliary Suite Roof Plan

Elevations

A201 Elevations Main Dwelling A202 Elevations Main Dwelling

A203 Elevations Auxiliary Suite

Sections

A301 Site Section SS

A302 Sections Main Dwelling A303 Sections Auxiliary Suite

Scope of Work For Build Permits 006540/006541:

All work to be completed in tandem with code consultant review* To be submitted under Small-Scale Multi-Unit Housing (SSMUH)

1. Demolish roof deck use above garden suite, return to roof only

2. Install conforming guardrail to restrict further access to roof

3. Demolish multiple non-conforming shed structures throughout

4. Install conforming handrail on access stairs where required. 5. Provide adequate clear headroom on access stairs. Install slip resistant nosings or other stair applications on access stairs.

6. Legitimize existing non-permitted floor area.

7. Install/verify/repair fire separation of as-built suites

8. Install conforming lighting on access stairs. 9. Renovate kitchen & main bathroom as per drawings.

10. Replace inoperable smoke alarms throughout.

11. Existing operable windows are recommended to have window opening restrictors installed so that the window opening will not exceed

100mm in width. 12. Demolish storage walls to reduce overall GFA to what is permitted by

zoning.

13. Resolve any other non-conforming items identified on site in collaboration with the Code Consultant and RMOW



brawings and specimenous as insumments service are and shall remain the property of Global Network Resource (GNAR Inc). They are not to be used on extensions of the projet or other projects, except by agreement in writing and appropriate compensation.

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jeremy@bunbury-surveys.com Jeremy Childs

CLIENT: Tom Syer and Tamara Little 8576 Drifter Way Whistler BC V8E 0G2

tom_syer@hotmail.com PROJECT: H69 - 8576 Drifter Way

8576 Drifter Way Whistler BC This Drawing Set is to be submitted as part of Development Variance Permit 1223 - DVP01223 is applied for in tandem with BP6540/6541 to bring as-built existing non-conforming construction into compliance with BCBC2024 and

Zoning and Parking Bylaw 303. Drawing size is 22"x34"


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VARIANCE PERMIT

Cover Sheet and Site Location Plan



(1) (A002)

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CLIENT:

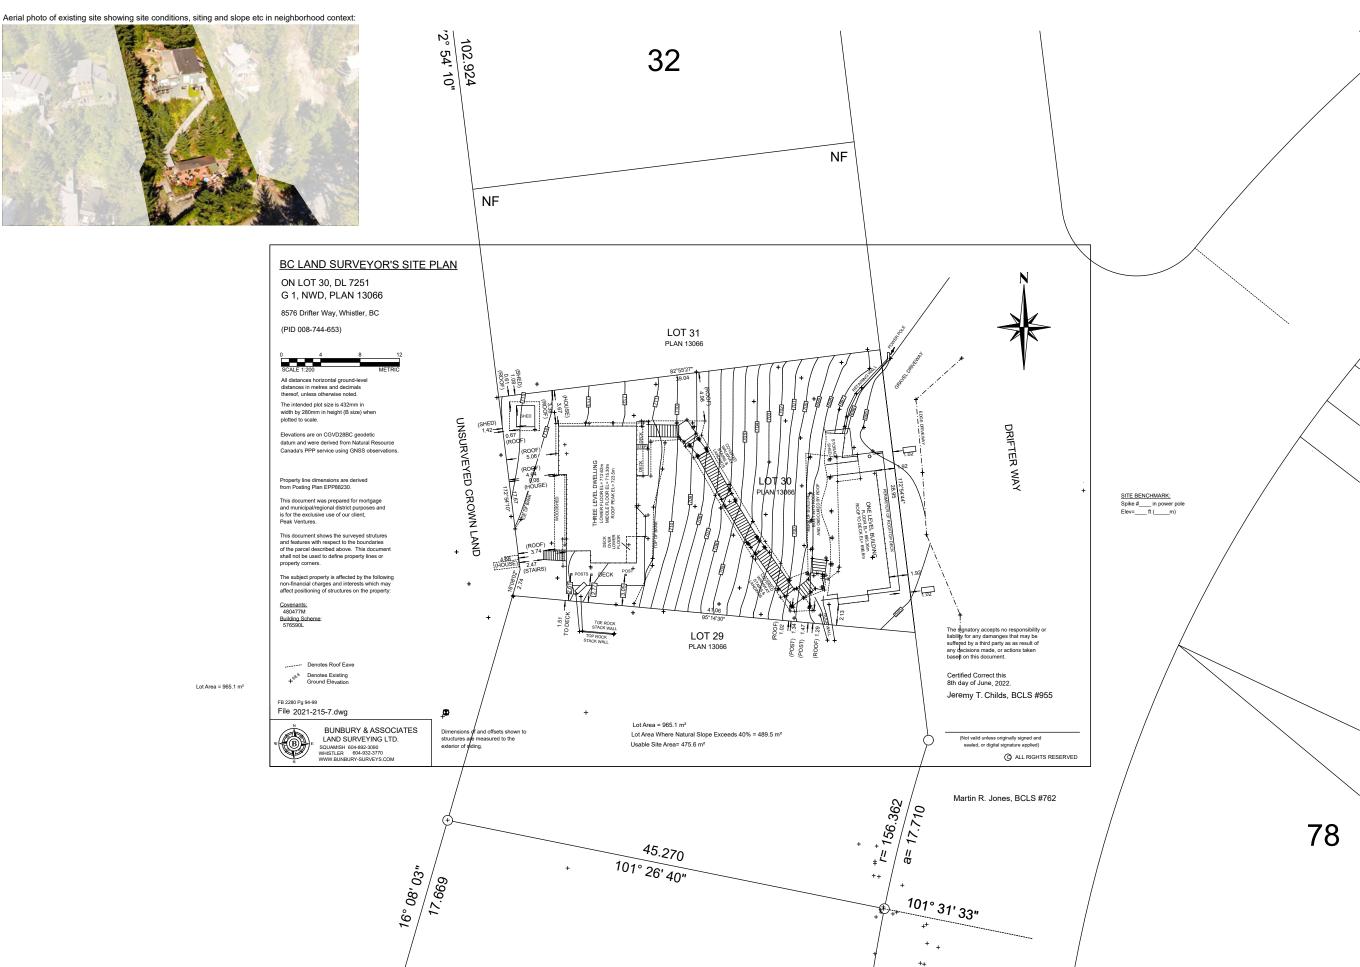Tom Syer and Tamara Little

8576 Drifter Way Whistler BC V8E 0G2 tom_syer@hotmail.com

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Drawing size is 22"x34" Prints on 11"x17" are at 50% scale


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SHEET TITLE:

Site Survey Plan





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#01 -ISSUED FOR DEVELOPMENT VARIANCE PERMIT

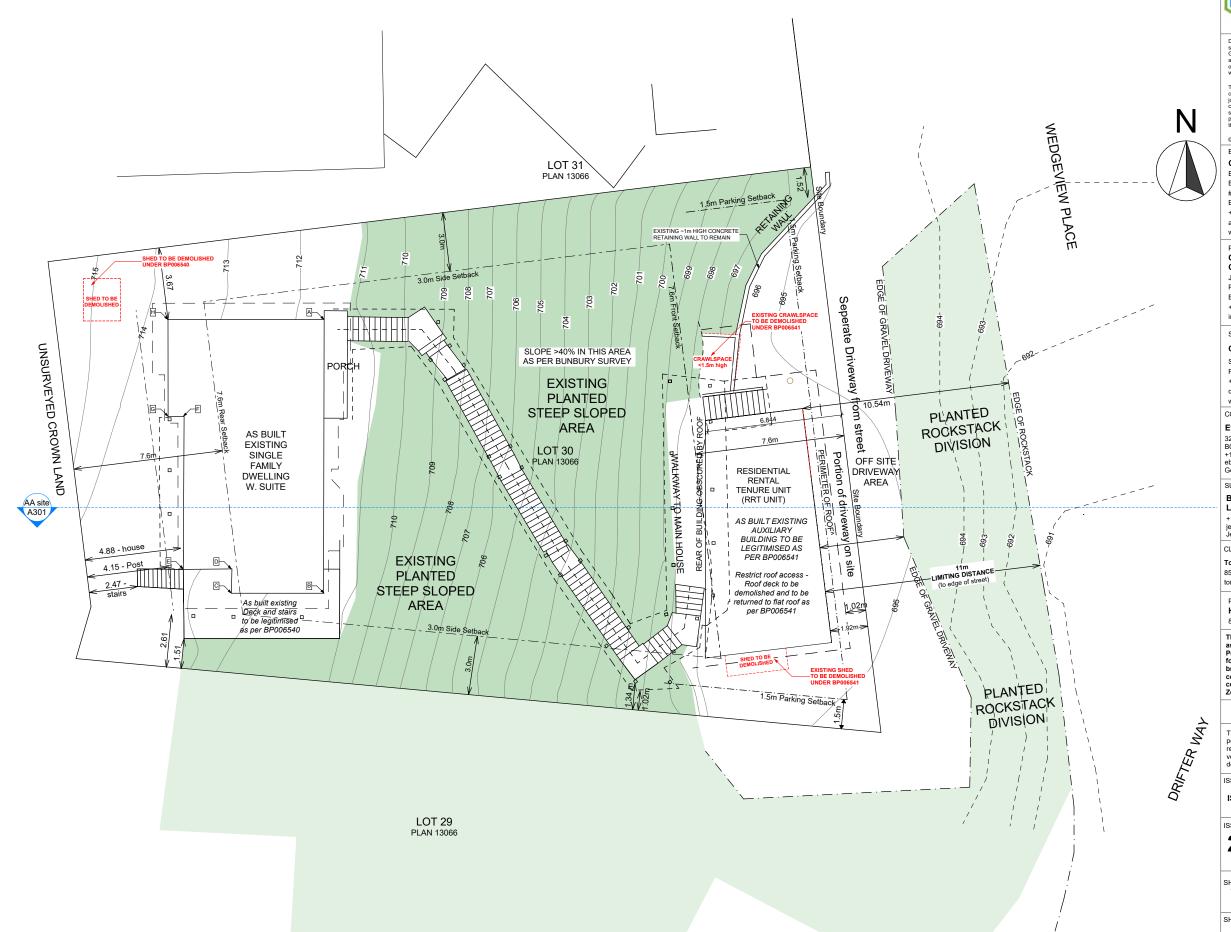
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2025-09-10

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Site and Service Plan -Demolition

SHEET ID:



A004
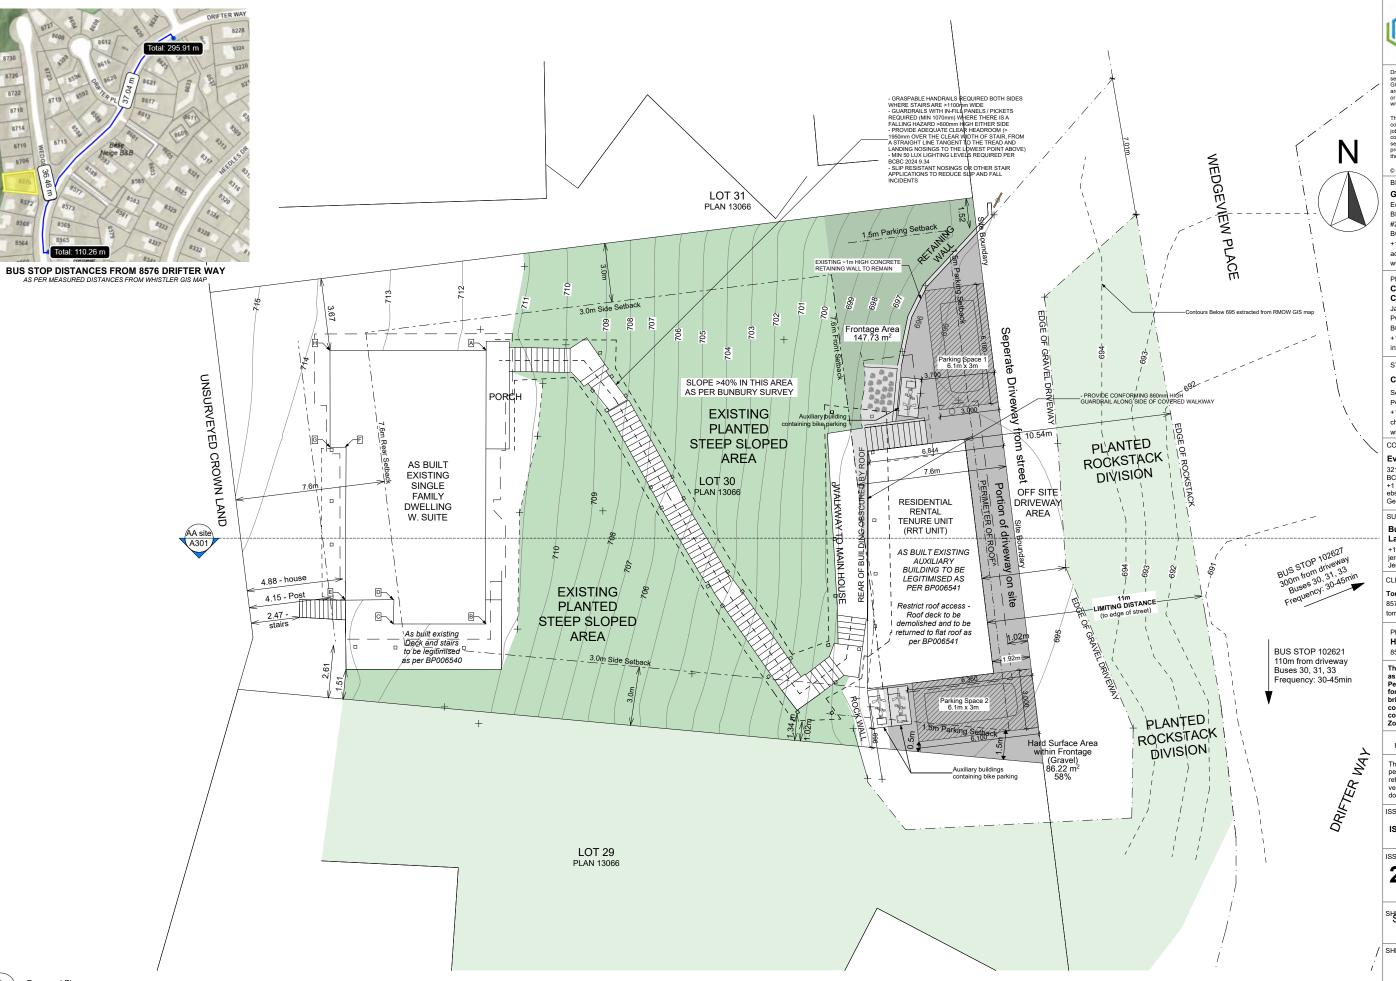
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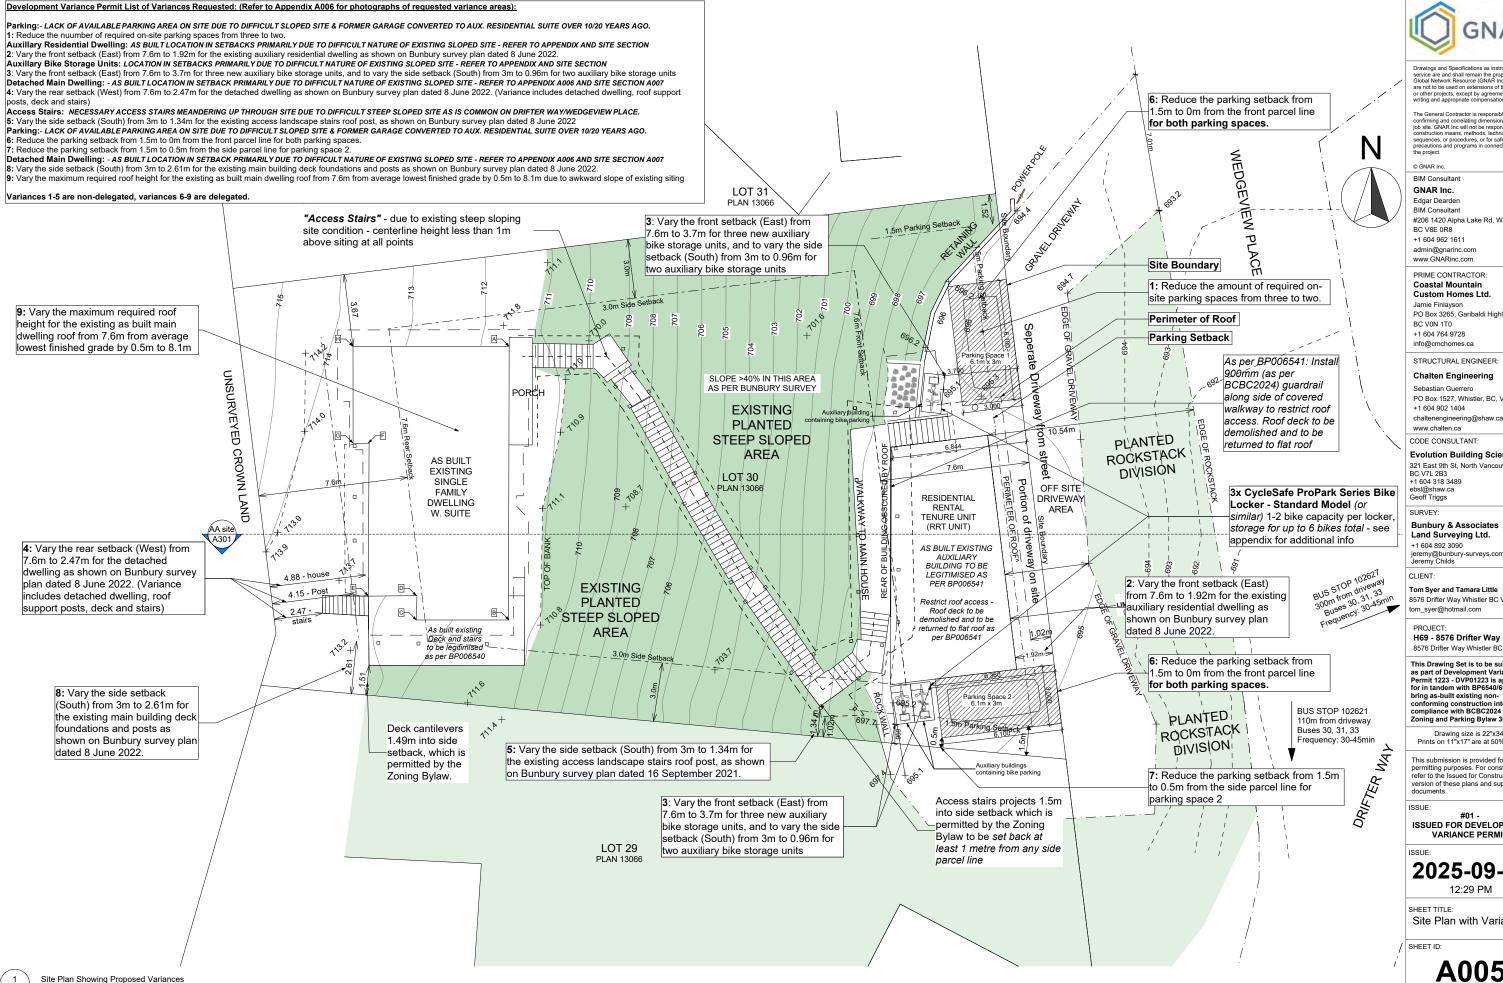
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VARIANCE PERMIT

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SHEET TITLE: Service Plan -Proposed

SCALE: 1/8" = 1'-0"



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Site Plan with Variances

1: Reduce the amount of required on-site parking spaces from three to two.

6: Reduce the parking setback from 1.5m to 0m from the front parcel line for both parking spaces. 7: Reduce the parking setback from 1.5m to 0.5m from the side parcel line for parking space 2. Auxilliary Residential Dwelling:

2: Vary the front setback (East) from 7.6m to 1.92m for the existing auxiliary residential dwelling as shown on Bunbury survey plan dated 8 June 2022. Auxillary Bike Storage Units:

3: Vary the front setback (East) from 7.6m to 3.7m for three new auxiliary bike storage units, and to vary the side setback (South) from 3m to 0.96m for two auxiliary bike storage units.













4: Vary the rear setback (West) from 7.6m to 2.47m for the detached dwelling as shown on Bunbury survey plan dated 8 June 2022. (Variance includes detached dwelling, roof support posts, deck and stairs)

8: Vary the side setback (South) from 3m to 2.61m for the existing main building deck foundations and posts as shown on Bunbury survey

9: Vary the maximum required roof height for the existing as built main dwelling roof from 7.6m from average lowest finished grade by 0.5m to 8.1m due to awkward slope of existing siting - refer to DVP-A07 - Site Section



j) As built Rear deck and stairs

f) steep sloping front of site









reduction





5: Vary the side setback (South) from 3m to 1.34m for the existing access landscape stairs roof post, as shown on Bunbury survey plan dated 8 June 2022.













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H69 - 8576 Drifter Way 8576 Drifter Way Whistler BC

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Appendix for Site Plan with Variances

Development Variance Permit List of Variances Requested: (Refer to Appendix A006 for photographs of requested variance areas):

Parking: LACK OF AVAILABLE PARKING AREA ON SITE DUE TO DIFFICULT SLOPED SITE & FORMER GARAGE CONVERTED TO AUX. RESIDENTIAL SUITE OVER 10/20 YEARS AGO. 1: Reduce the nuumber of required on-site parking spaces from three to two.

Auxillary Residential Dwelling: AS BUILT LOCATION IN SETBACKS PRIMARILY DUE TO DIFFICULT NATURE OF EXISTING SLOPED SITE - REFER TO APPENDIX AND SITE SECTION

2: Vary the front setback (East) from 7.6m to 1.92m for the existing auxiliary residential dwelling as shown on Bunbury survey plan dated 8 June 2022.

Auxillary Bike Storage Units: LOCATION IN SETBACKS PRIMARILY DUE TO DIFFICULT NATURE OF EXISTING SLOPED SITE - REFER TO APPENDIX AND SITE SECTION

3: Vary the front setback (East) from 7.6m to 3.7m for three new auxiliary bike storage units, and to vary the side setback (South) from 3m to 0.96m for two auxiliary bike storage units Detached Main Dwelling: - AS BUILT LOCATION IN SETBACK PRIMARILY DUE TO DIFFICULT NATURE OF EXISTING SLOPED SITE - REFER TO APPENDIX A006 AND SITE SECTION A007 4: Vary the rear setback (West) from 7.6m to 2.47m for the detached dwelling as shown on Bunbury survey plan dated 8 June 2022. (Variance includes detached dwelling, roof support

Access Stairs: NECESSARY ACCESS STAIRS MEANDERING UP THROUGH SITE DUE TO DIFFICULT STEEP SLOPED SITE AS IS COMMON ON DRIFTER WAY/WEDGEVIEW PLACE.


5: Vary the side setback (South) from 3m to 1.34m for the existing access landscape stairs roof post, as shown on Bunbury survey plan dated 8 June 2022
Parking:- LACK OF AVAILABLE PARKING AREA ON SITE DUE TO DIFFICULT SLOPED SITE & FORMER GARAGE CONVERTED TO AUX. RESIDENTIAL SUITE OVER 10/20 YEARS AGO.

6: Reduce the parking setback from 1.5m to 0m from the front parcel line for both parking spaces. 7: Reduce the parking setback from 1.5m to 0.5m from the side parcel line for parking space 2.

Detached Main Dwelling: - AS BUILT LOCATION IN SETBACK PRIMARILY DUE TO DIFFICULT NATURE OF EXISTING SLOPED SITE - REFER TO APPENDIX A006 AND SITE SECTION A007 8: Vary the side setback (South) from 3m to 2.61m for the existing main building deck foundations and posts as shown on Bunbury survey plan dated 8 June 2022.

9: Vary the maximum required roof height for the existing as built main dwelling roof from 7.6m from average lowest finished grade by 0.5m to 8.1m due to awkward slope of existing siting

Variances 1-5 are non-delegated, variances 6-9 are delegated.

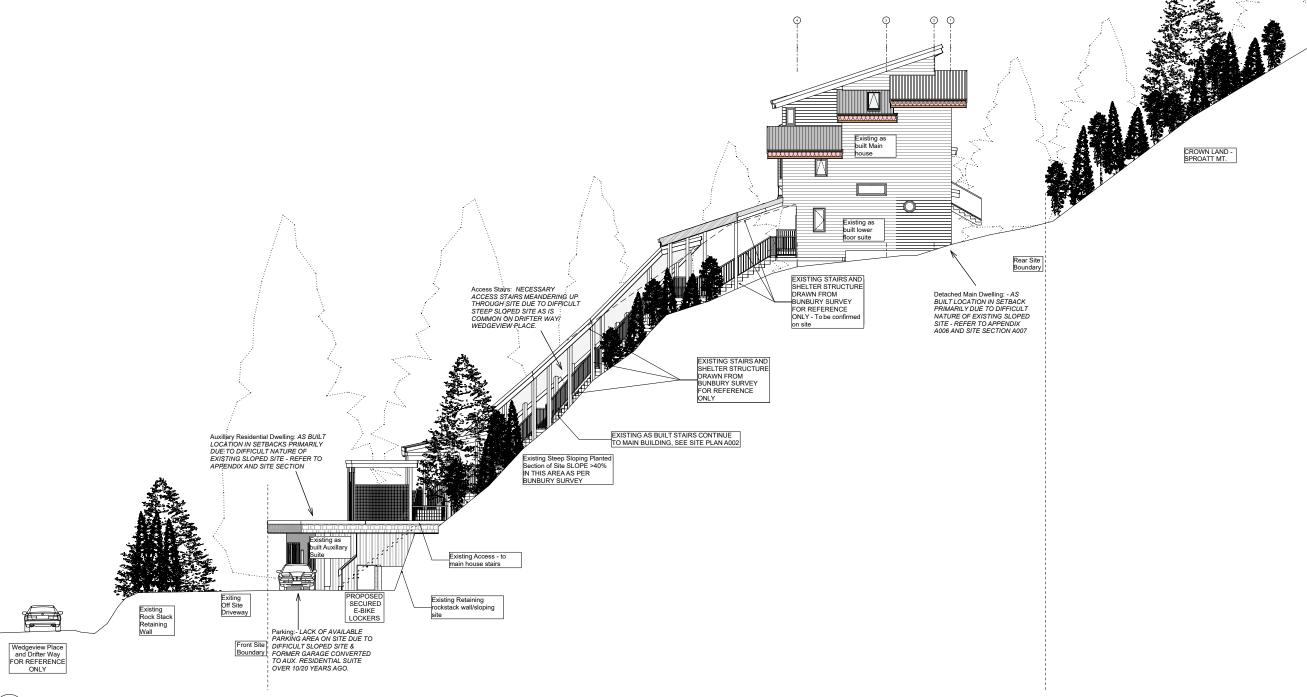



Site Section SS

SCALE: 1/8" = 1'-0"



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8576 Drifter Way Whistler BC This Drawing Set is to be submitted as part of Development Variance Permit 1223 - DVP01223 is applied for in tandem with BP6540/6541 to

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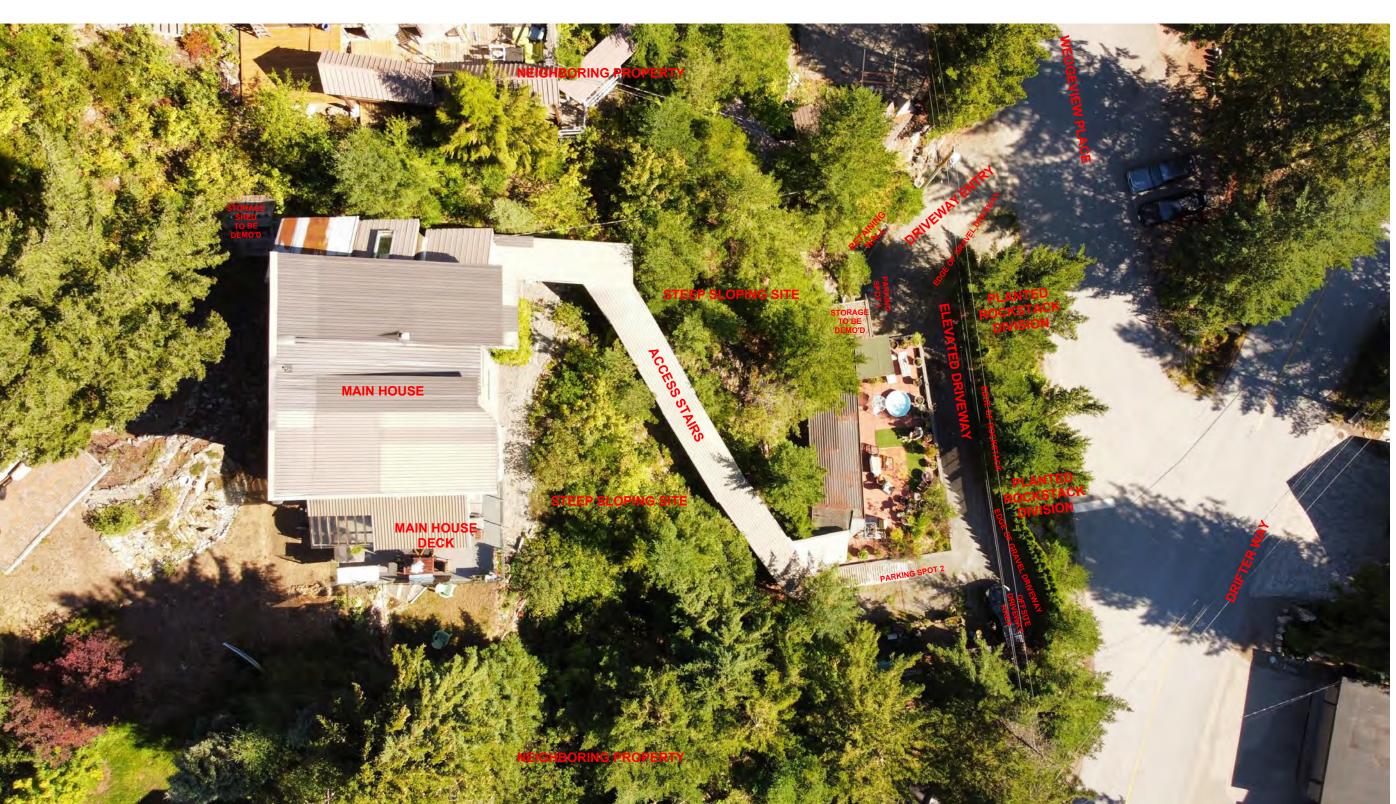
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Site Section





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SHEET TITLE: Aerial Photo

SHEET ID:

DPA CONSIDERATIONS: High Risk Wildfire Areas:

These areas are typically developed areas or developable land near or adjacent to forest. In these areas, a number of building features, landscaping, site clearing and tree thinning may be required.

The following guidelines apply to all areas shown on Schedule S:


- (a) Where a distance is specified by these guidelines for the purpose of establishing an area that should be cleared or remain free of vegetation, the distance should be measured from the outermost part of the building to: (i) the distance specified in the guideline;
- (ii) the property line, unless permission has been granted by the adjacent property owner; or
- (iii) the boundary of an environmentally sensitive area unless clearing is carried out in accordance with the recommendations of a QEP and approved in writing by the municipality's Manager of Environmental Stewardship whichever is
- (b) Where the municipality receives a FireSmart® Assessment in respect of a property which is the subject of an application for a development permit under this section, the municipality may choose to apply, as permit conditions, the recommendations of the report instead of, or in addition to, the guidelines in this
- (c) Where these guidelines warrant tree removal preference should be given to: (i) retaining the largest and healthiest trees;
- (ii) removing coniferous vegetation located closest to principal buildings; and (iii) retaining deciduous trees and vegetation.

HIGH RISK AREAS

In areas shown as "High Risk" on Schedule S, the following guidelines apply:

- (a) New and existing coniferous vegetation within 10 metres and where practical 20 metres of principal buildings should maintain a typical spacing between tree canopies and between tree canopies and principal buildings of at least 3 metres. This can be achieved by (i) planting/removing conifers to achieve a trunk to trunk or trunk to building spacing of 6 metres or more; or
- (ii) limbing mature trees, selecting species with narrow canopies or applying similar landscaping techniques to obtain a minimum 3 metre vertical and horizontal separation between tree canopies and between tree canopies and principal buildings
- (b) Dead branches and twigs should be cleared within 20 metres of principal buildings. Standing dead trees with a caliper of 17 centimetres or more should be topped at 3 metres and cleared of all branches. Where dead branches are attached to logs greater than 17 centimetres wide or trees they should be trimmed to the trunk of the tree or log and in the case of trees, to a height of 2 metres.
- (c) Planting native deciduous trees and shrubs is encouraged especially in cases where coniferous vegetation has been removed.
- (e) The use of bark mulch and similar organic ground cover in landscaped areas within 10 metres of buildings is discouraged.
- (f) Exterior building surfaces, including deck surfacing, roofing and cladding, that is situated under, or within 6 metres of, coniferous vegetation should be nonflammable materials such as stone, metal, concrete, masonry or fiber-cement.
- (g) Fire-resistant or non-flammable cladding that is consistent with mountain character (e.g., fiber-cement siding, stone, logs or heavy timbers) is encouraged. Stucco and vinyl siding are discouraged
- (h) Windows and doors should utilize double-paned or triple-paned glass; tempered glass is ideal, and single pane glass is discouraged.
- (i) Eaves should be closed and vents screened with 3 millimetre wire
- (i) The undersides of balconies, decks or open foundations should be sheathed with fire-resistant materials.
- (k) Auxiliary buildings and fuel tanks should be located as far away from principal buildings as possible. A distance of 15 metres or more is ideal. Where a distance of 15 metres or more is impractical, guidelines in this section that apply to principal buildings should be applied to accessory buildings.
- (I) Chimneys for wood burning fireplaces should have spark arrestors.
- (m) Gutters should be made of metal.
- (n) Cladding should be free of gaps and holes and separated from the ground with a minimum of 15 centimeters of non-combustible ground to siding clearance.

SCALE: 1/8" = 1'-0"

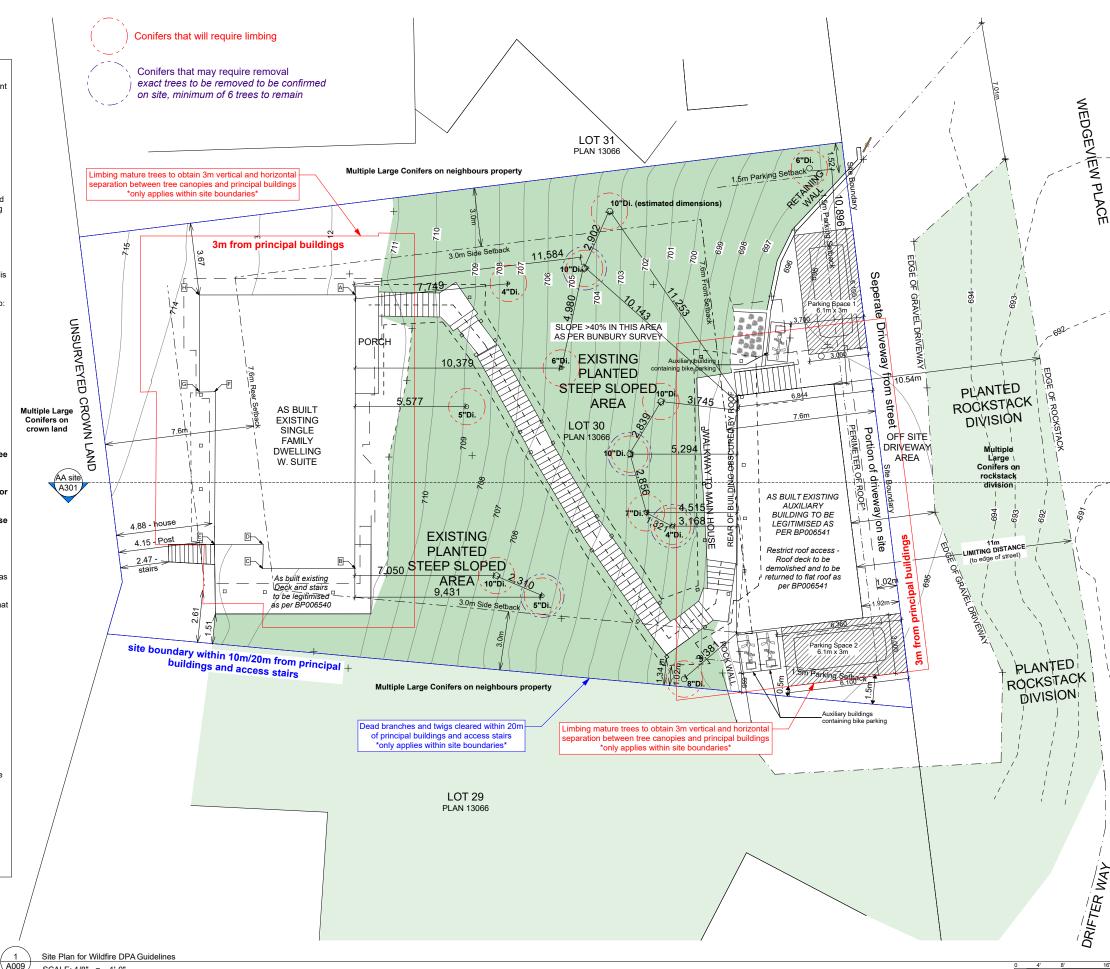

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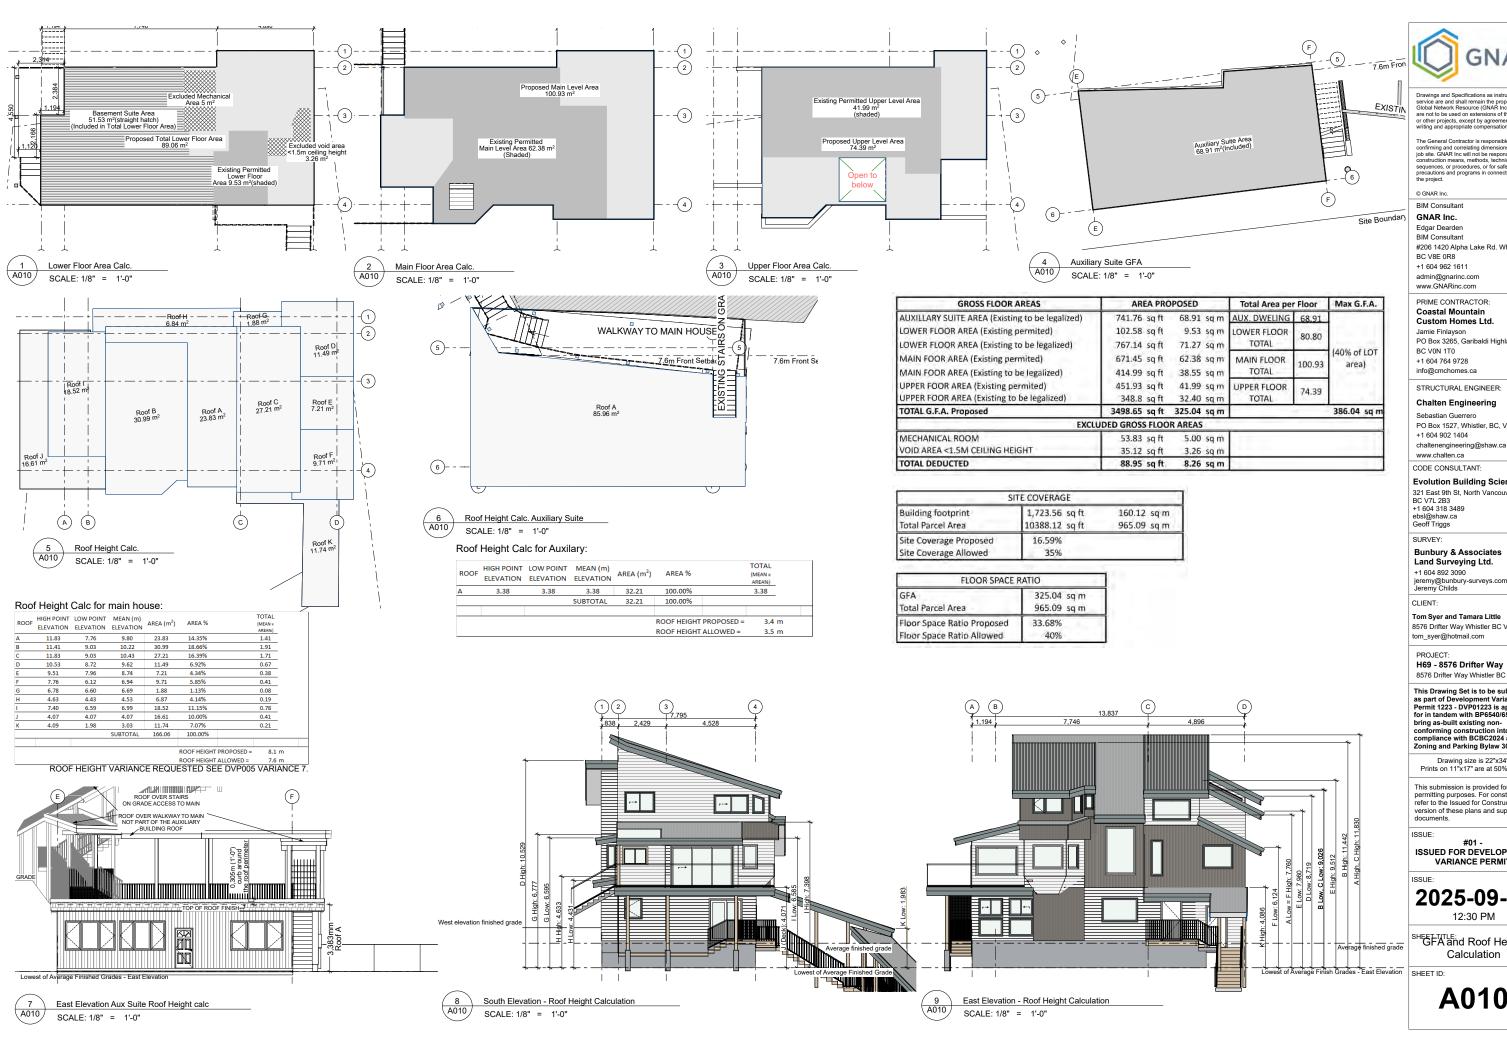
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Wildfire DPA Guideline



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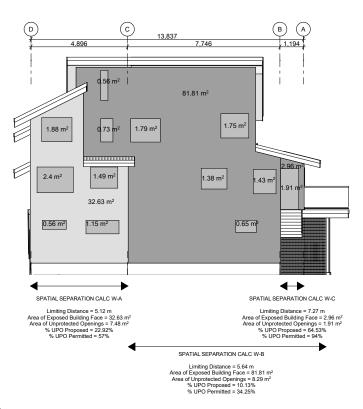
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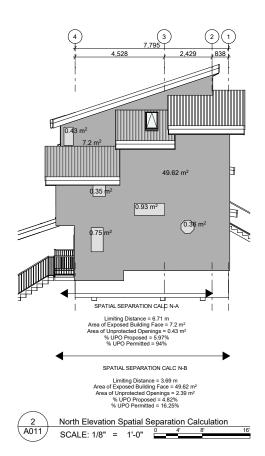
HEGFATTLE: Roof Height


Calculation




West Elevation Spatial Separation Calculation

SCALE: 1/8" = 1'-0"



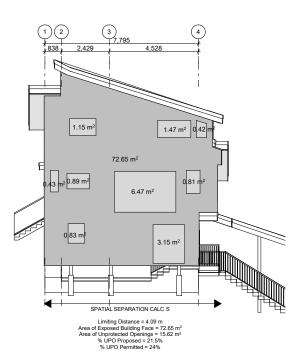


South Elevation Spatial Separation Calculation SCALE: 1/8" = 1'-0"

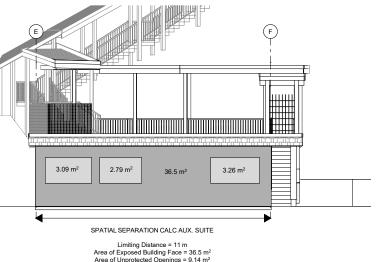

Area of Unprotected Openings = 9.14 m² % UPO Proposed = 25.0 %

East Elevation Auxiliary Suite Spatial Separation Calculation SCALE: 1/8" = 1'-0"

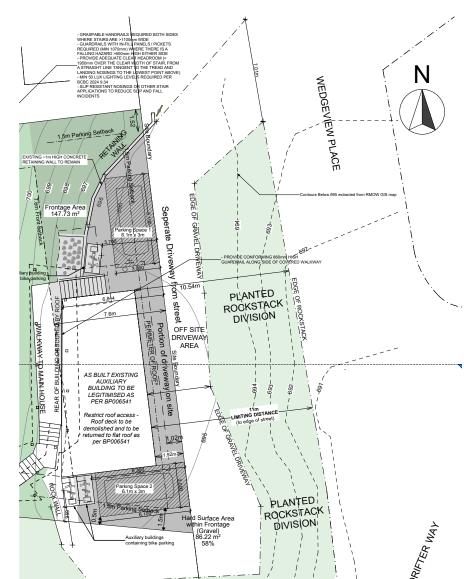



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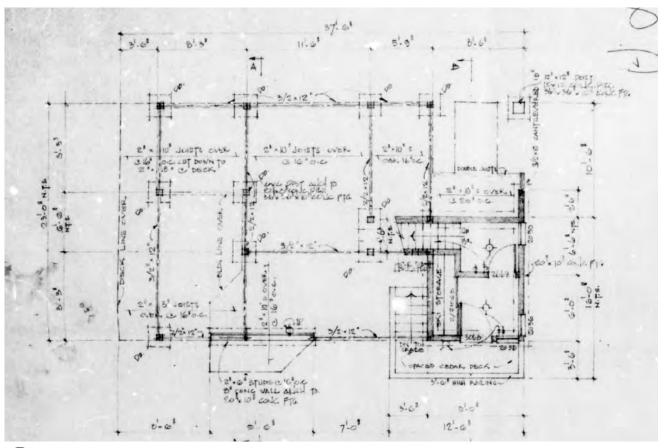
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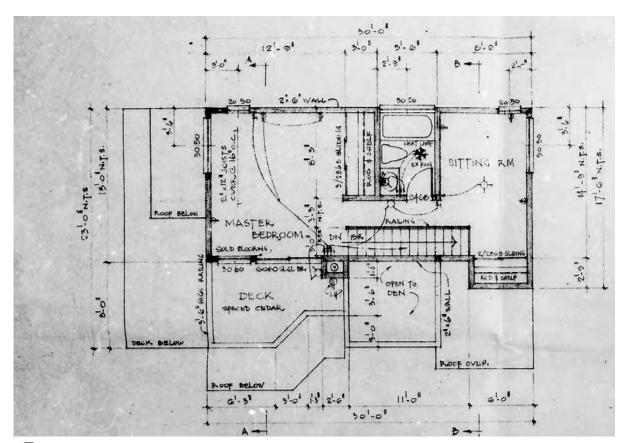
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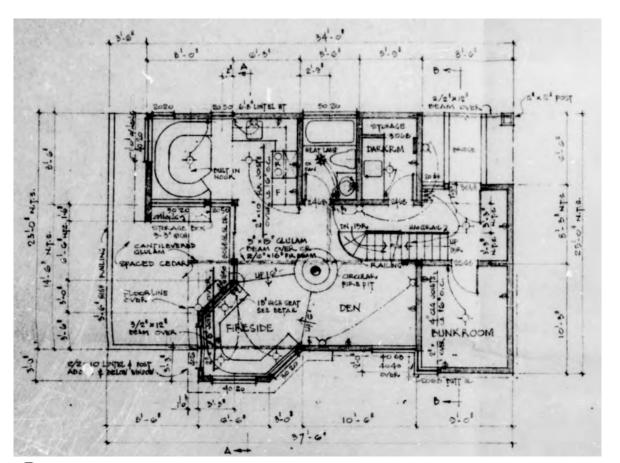
Spatial Separation Calculation




1 Foundation Existing Plans
NOT TO SCALE



3 Existing Upper Floor Plan
A101 NOT TO SCALE



Existing Main Floor Plan
NOT TO SCALE

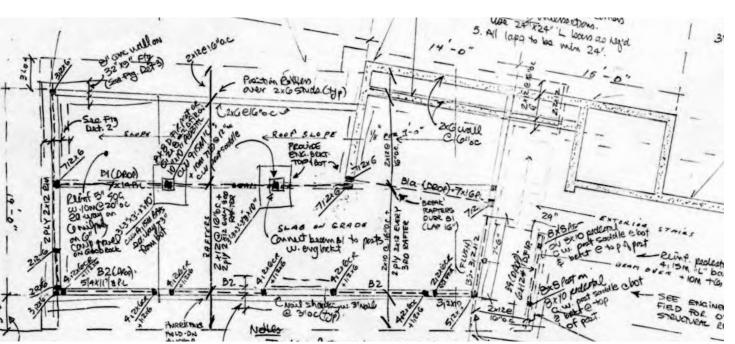

4 Existing Plan on File - Garage

A101 NOT TO SCALE

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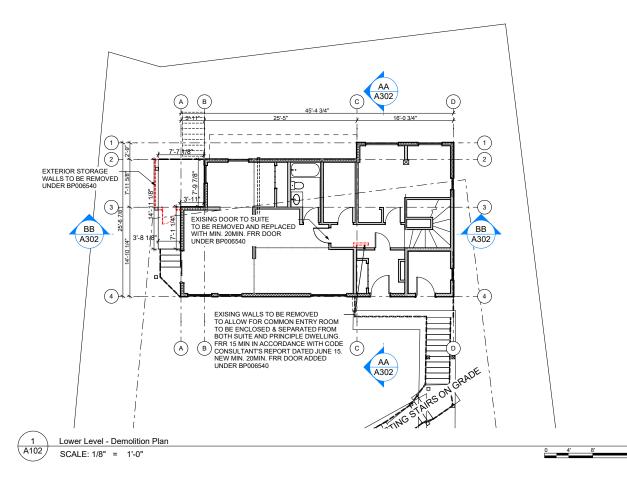
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SHEET TITLE:
Existing Plans on File


SHEET ID:



(A) (B) 45'-4 3/4" REPLACE EXISTING WINDOW (RAISED SILL REPLACE EXISTING DOOR UNDER BP006540 BB A302 ВВ A302 ADJUST STEP &
BENCH INGGAS FIREPLACE REPLACE EXISTING WINDOW WITH NEW 10 SLIDER DOOF (A) (B) (c) AA A302 Main Level - Demolition Plan

SCALE: 1/8" = 1'-0"

CC A303 SHED TO BE REMOVED--CRAWLSPACE TO BE REMOVED UNDER BP00654 NG RETAINING WALL DD A303 DD 6 (E) CC A303 Site Boundary Auxiliary Suite Level - Demolition Plan SCALE: 1/8" = 1'-0"

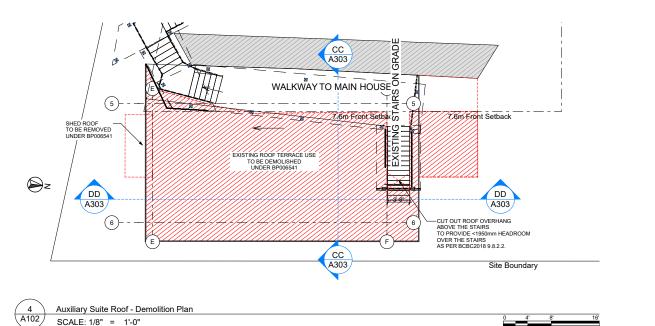

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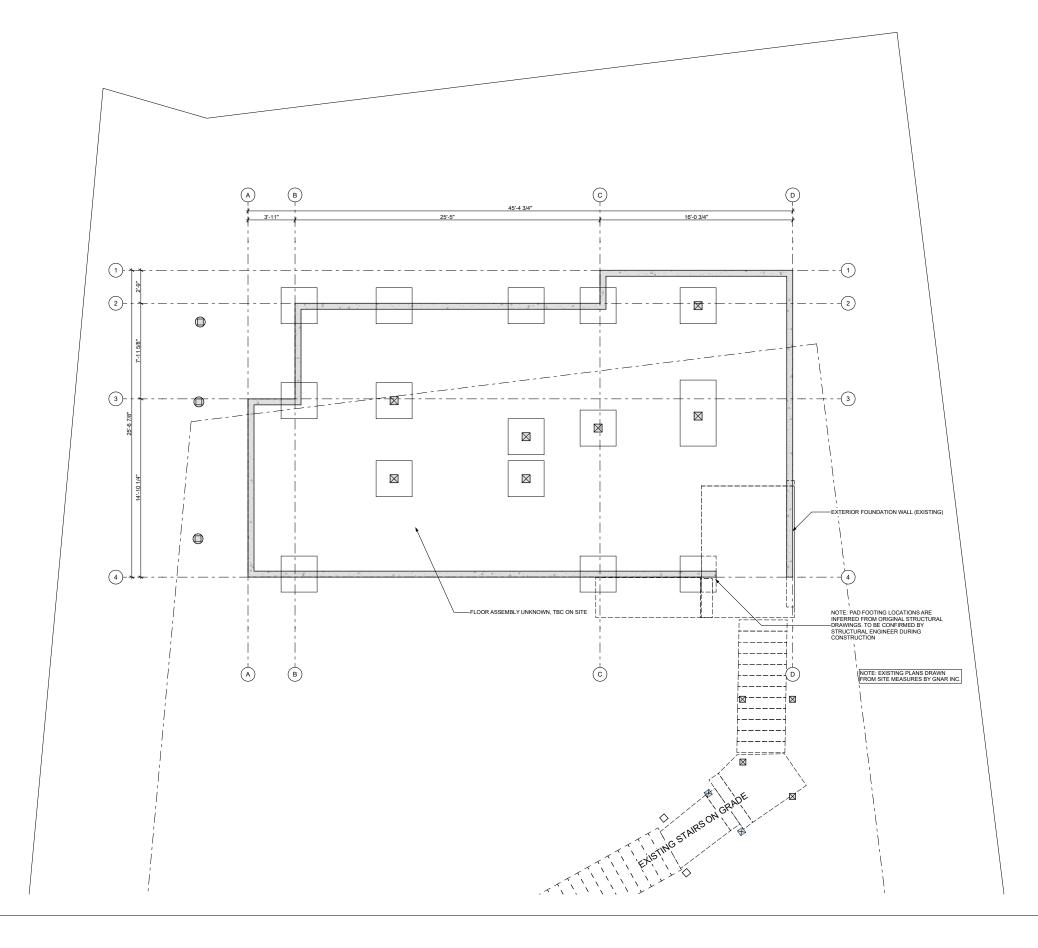
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Demolition Plans





SCALE: 1/4" = 1'-0"

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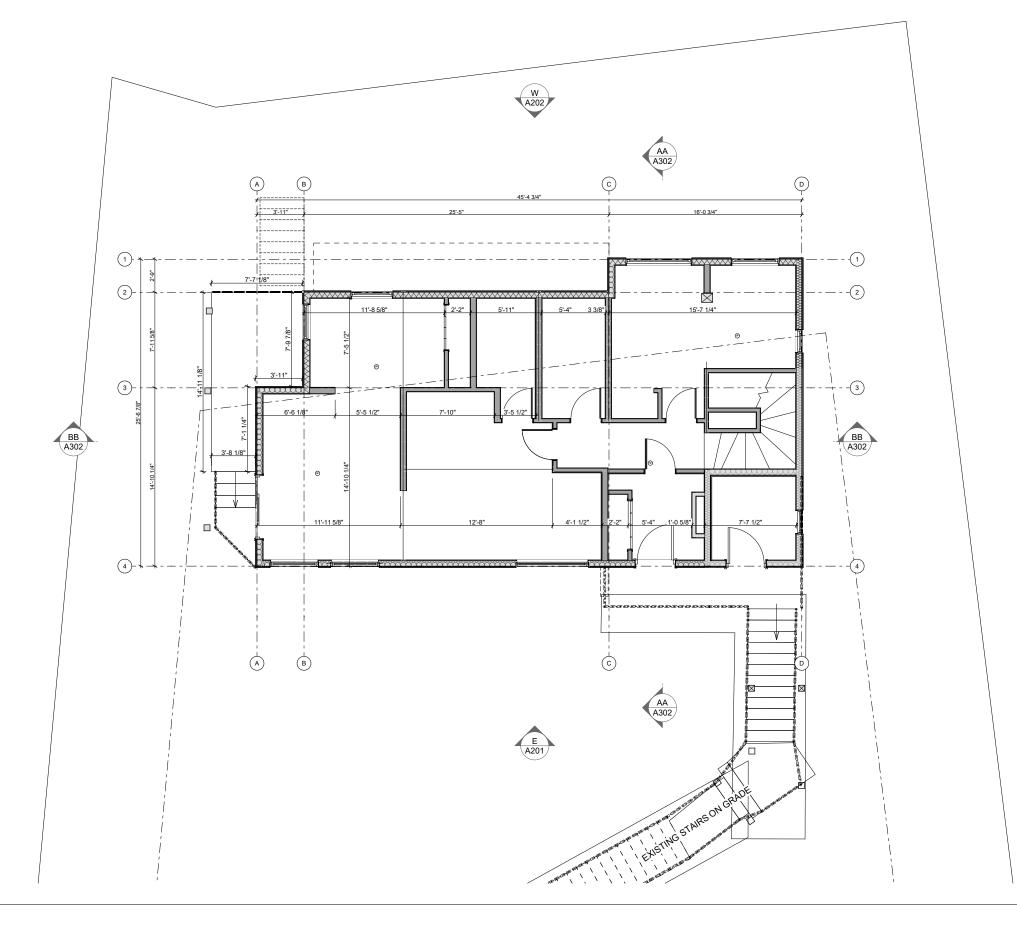
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12:30 PM SHEET TITLE:

Foundation Plan





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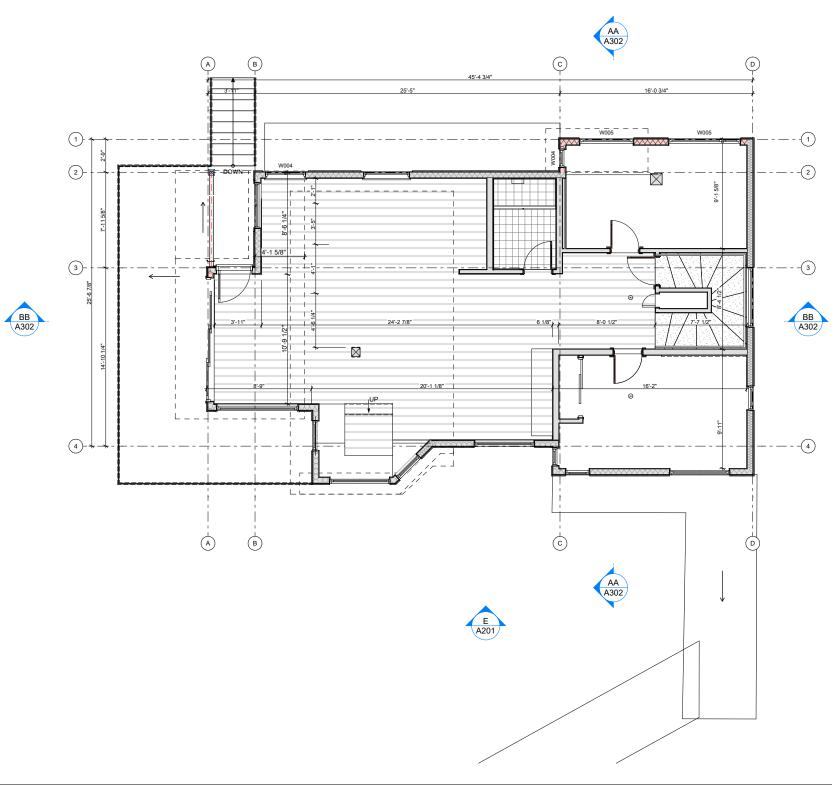
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SHEET TITLE:

Lower Level Suite Plan









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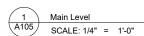
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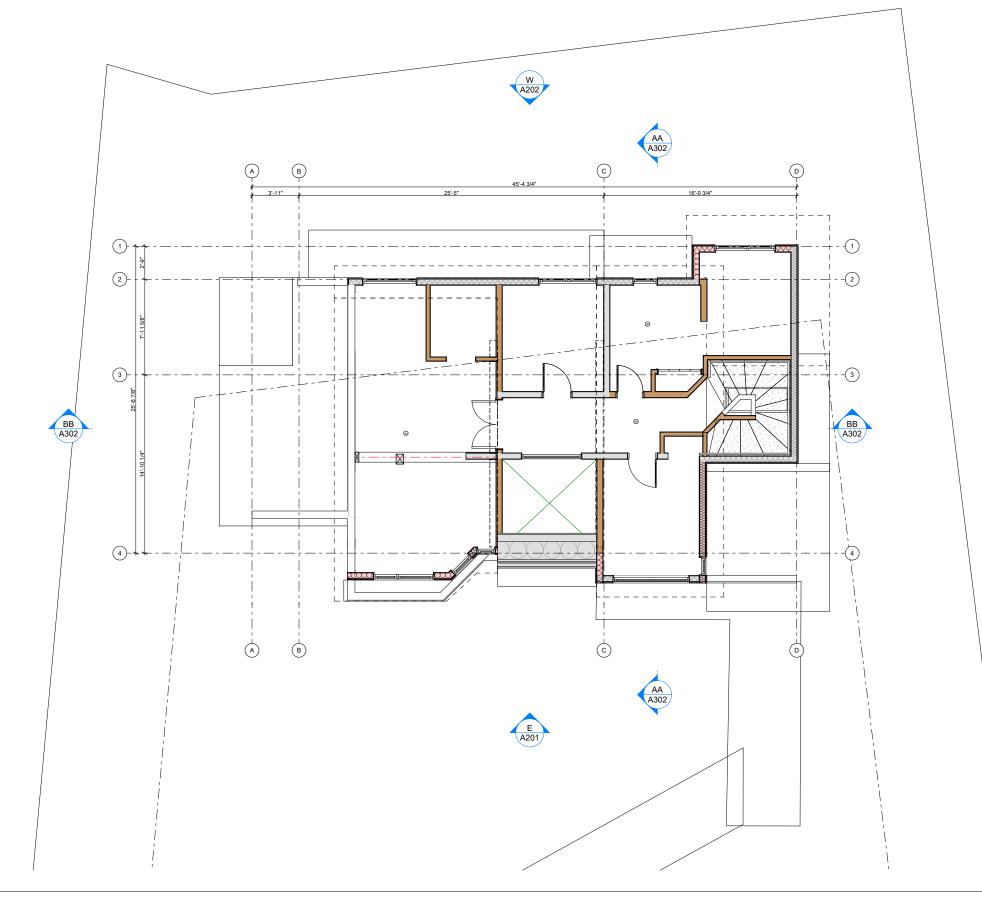
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SHEET TITLE:

Main Level Plan









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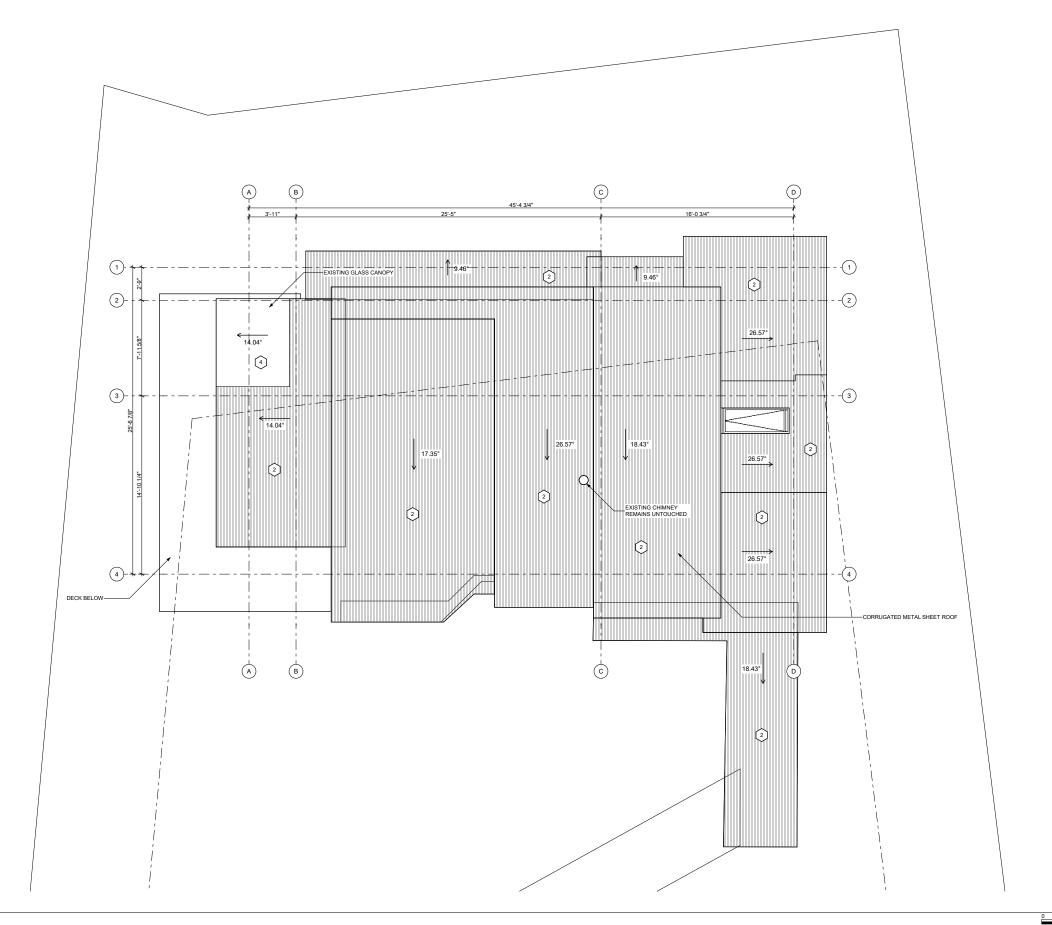
Upper Level Plan

A106

Upper Level SCALE: 1/4" = 1'-0"

EXTERIOR FINISHES:

- HORIZONTAL WOOD SIDING
- VERTICAL WOOD SIDING
- CORRUGATED METAL ROOF SHEETING
- FASCIA METAL FLASHING
- CLEAR ROOFING
- WOODEN BOARD AND BATTEN SIDING
- WOODEN POST/BEAM
- GLASS GUARDRAIL PICKET RAILING
- WOOD SOFFIT
- WOODEN TRELLIS PANEL
- METAL TRELLIS CEDAR SHAKE FASCIA





SCALE: 1/4" = 1'-0"



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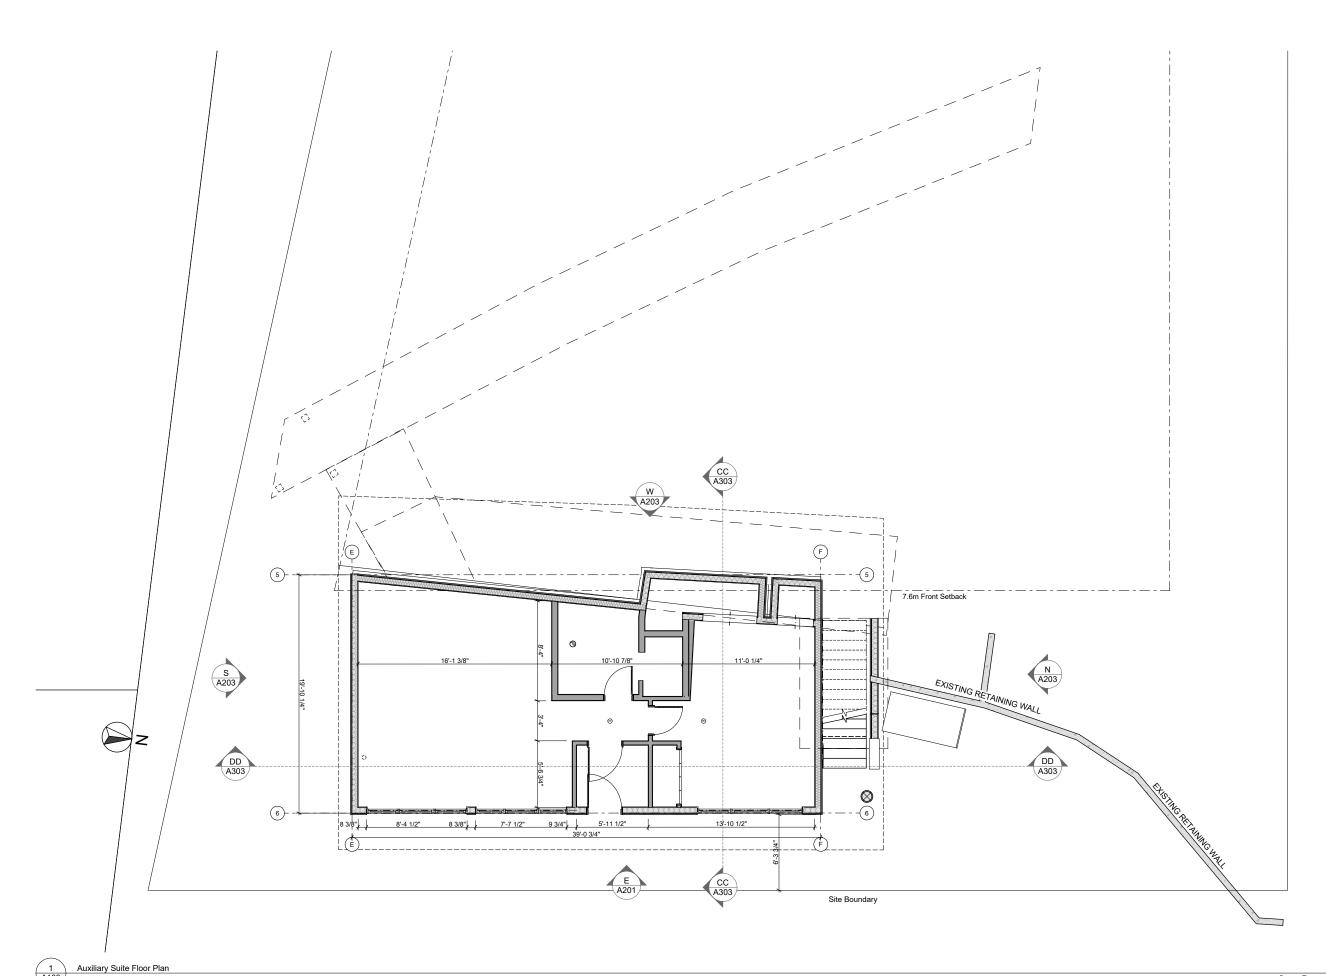
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2025-09-10 12:30 PM

SHEET TITLE:

Roof Plan

SHEET ID:



SCALE: 1/4" = 1'-0"

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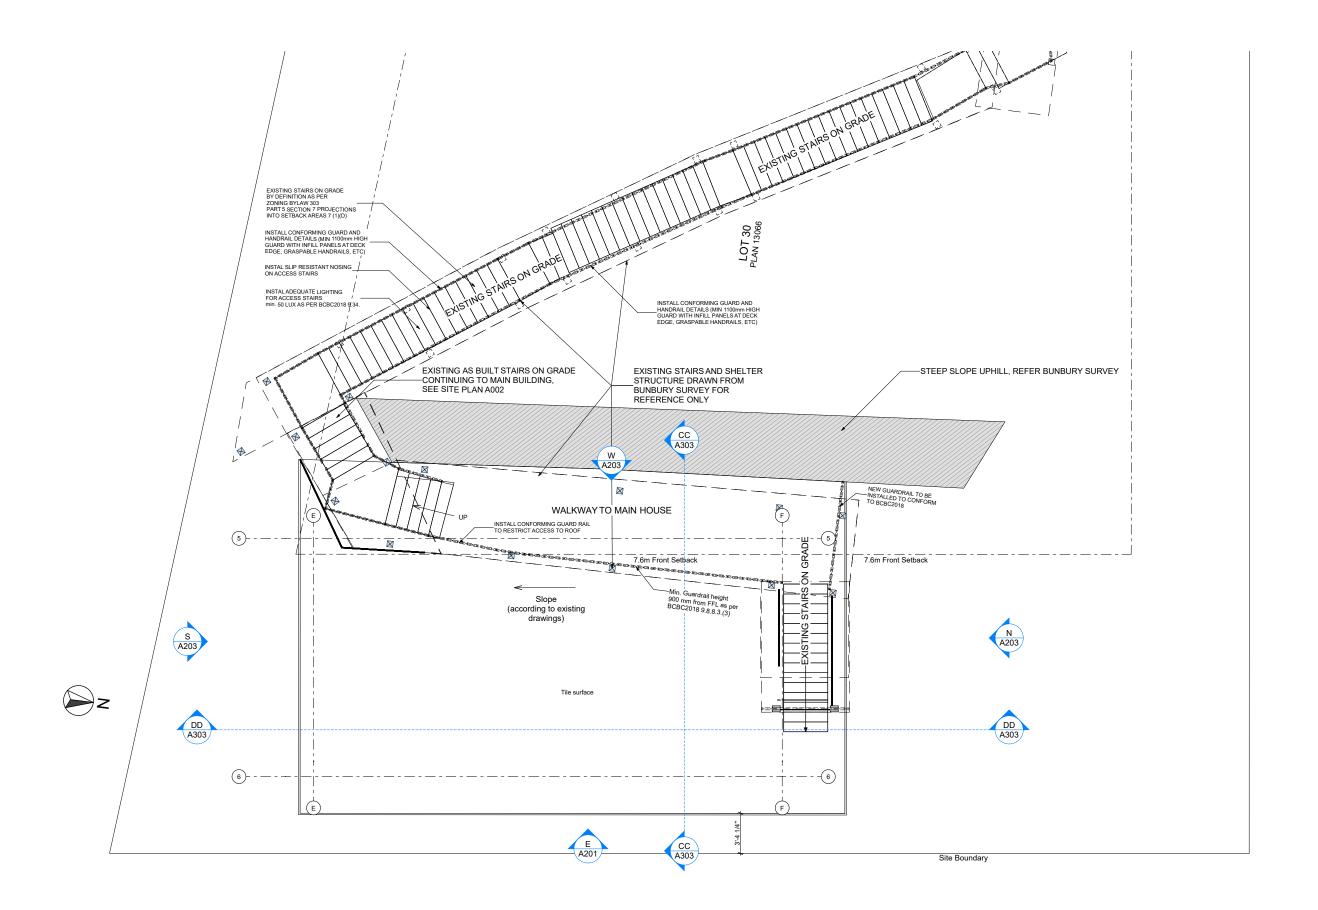
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#01 ISSUED FOR DEVELOPMENT
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2025-09-10 12:30 PM

SHEET TITLE:
Auxiliary Suite Plan





Auxiliary Suite Roof

SCALE: 1/4" = 1'-0"



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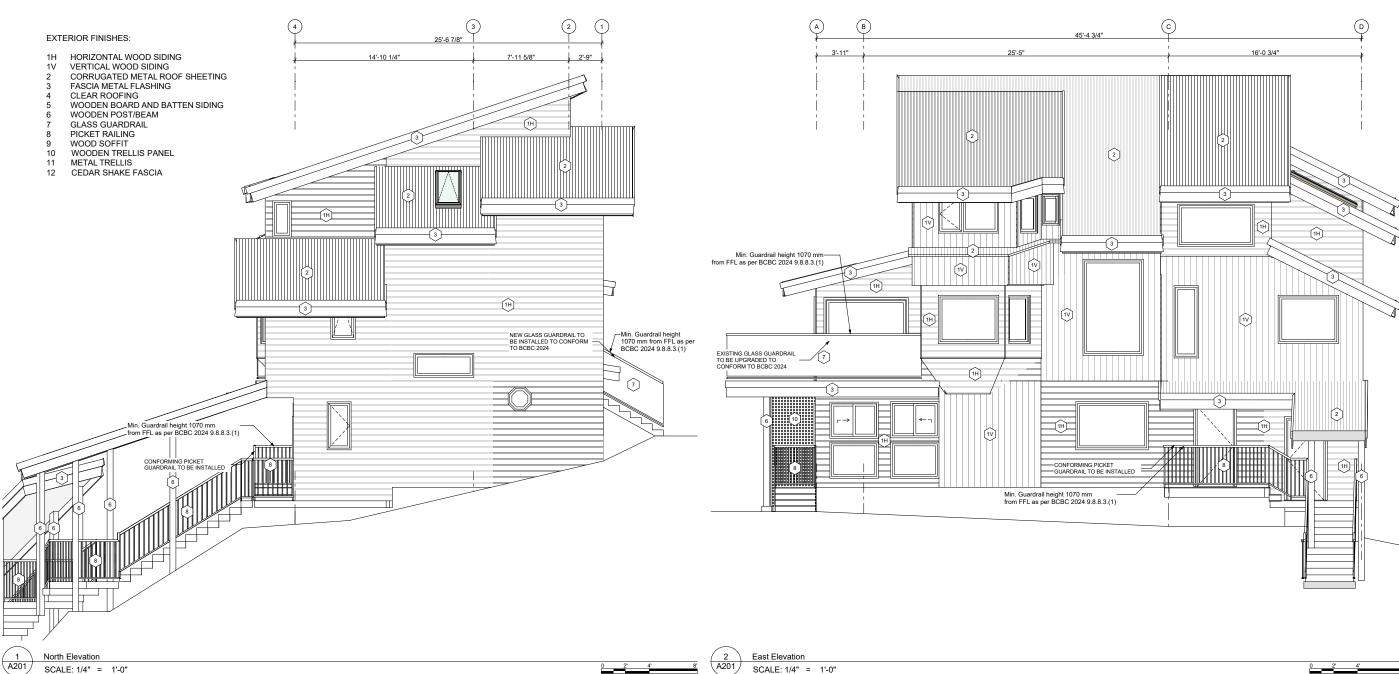
ISSUE:

#01 ISSUED FOR DEVELOPMENT
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2025-09-10 12:30 PM

SHEET TITLE:

Auxiliary Suite Roof Plan





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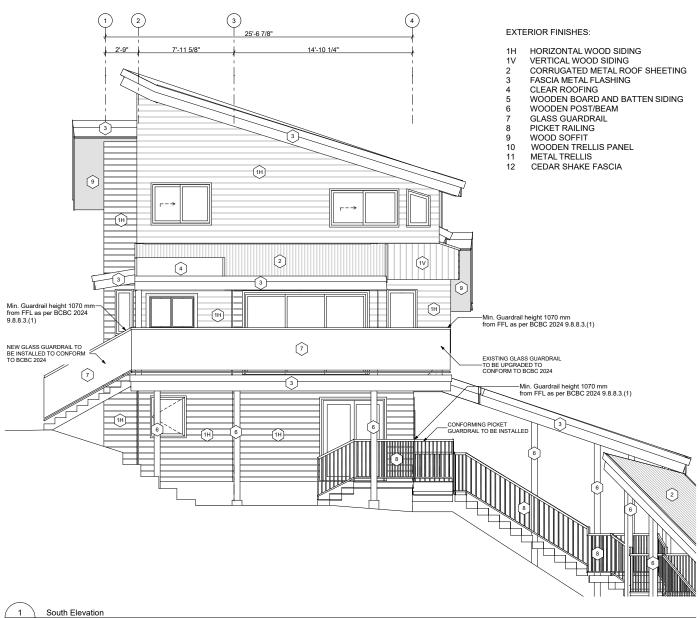
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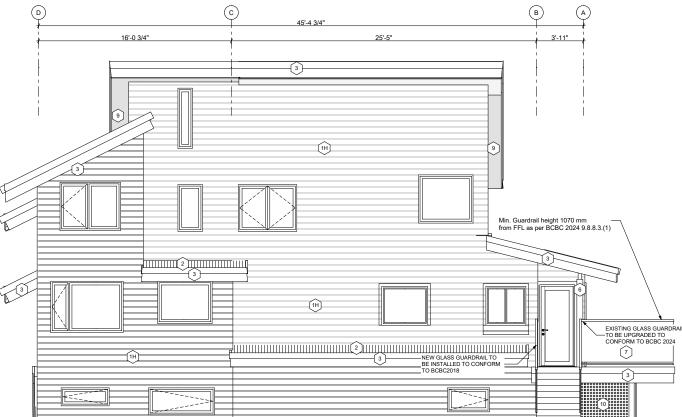
12:30 PM

SHEET TITLE:

Elevations Main Dwelling



SCALE: 1/4" = 1'-0"



West Elevation SCALE: 1/4" = 1'-0"

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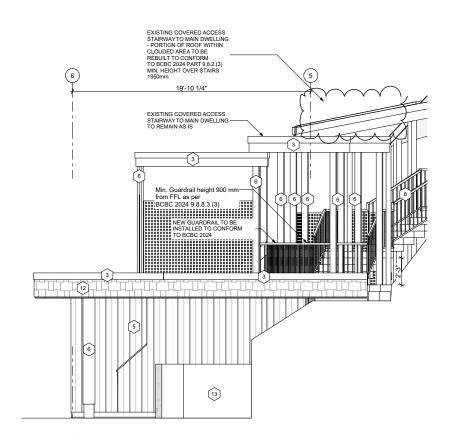
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2025-09-10

12:30 PM

SHEET TITLE:

Elevations Main Dwelling



HORIZONTAL WOOD SIDING VERTICAL WOOD SIDING CORRUGATED METAL ROOF SHEETING FASCIA METAL FLASHING CLEAR ROOFING WOODEN BOARD AND BATTEN SIDING WOODEN POST/BEAM GLASS GUARDRAIL PICKET RAILING WOOD SOFFIT WOODEN TRELLIS PANEL EXISTING COVERED ACCESS STAIRWAY TO MAIN DWELLING PORTION OF ROOF WITHIN CLOUDED AREA TO BE REBUILT TO CONFORM TO BCBC 2024 PART 9.8.2. (3) MIN. HEIGHT OVER STAIRS 1950mm METAL TRELLIS CEDAR SHAKE FASCIA 12 13 EXISTING COVERED CONCRETE -WALKWAY / STAIRWAY TO MAIN DWELLING TO REMAIN EXISTING COVERED

WALKWAY / STAIRWAY TO

MAIN DWELLING TO REMAIN 6 NEW GUARDRAIL TO BE -INSTALLED TO CONFORM TO BCBC 2024 900 mm from FFL as per BCBC 2024 9.8.8.3.(3) FINISHED GRADE EXISTING CONCRETE

RETAINING WALL ~1.2n

HEIGHT TO REMAIN EXISTING STAIRS ON —
GRADE TO —
MAIN
DWELLING 13 Exterior door requires glazing -Windows to have max. U value of 1.22 East Elevation Auxillary Suite (3 (A203)

North Elevation Auxillary Suite SCALE: 1/4" = 1'-0"

EXISTING COVERED ACCESS STAIRWAY TO MAIN DWELLING - PORTION OF ROOF WITHIN CLOUDED AREA TO BE REBUILT TO CONFORM (6) 19'-10 1/4" EXISTING COVERED ACCESS
-STAIRWAYTO MAIN DWELLING
TO REMAIN AS IS Min. Guardrail height 900 mm from FFL as pe BCBC 2024 9.8.8.3.(3) (12)

EXISTING COVERED ACCESS STAIRWAYTO MAIN DWELLING - PORTION OF ROOF WITHIN CLOUDED AREA TO BE REBUILT TO CONFORM TO BCBC 2024 PARTS 8.2.(3) MIN. HEIGHT OVER STAIRS 1950mm 39'-0 3/4" NEW GUARDRAIL TO BE INSTALLED TO CONFORM TO BCBC 2024

South Elevation Auxillary Suite A203 SCALE: 1/4" = 1'-0"

4 A203

SCALE: 1/4" = 1'-0"

East Elevation Auxillary Suite SCALE: 1/4" = 1'-0"

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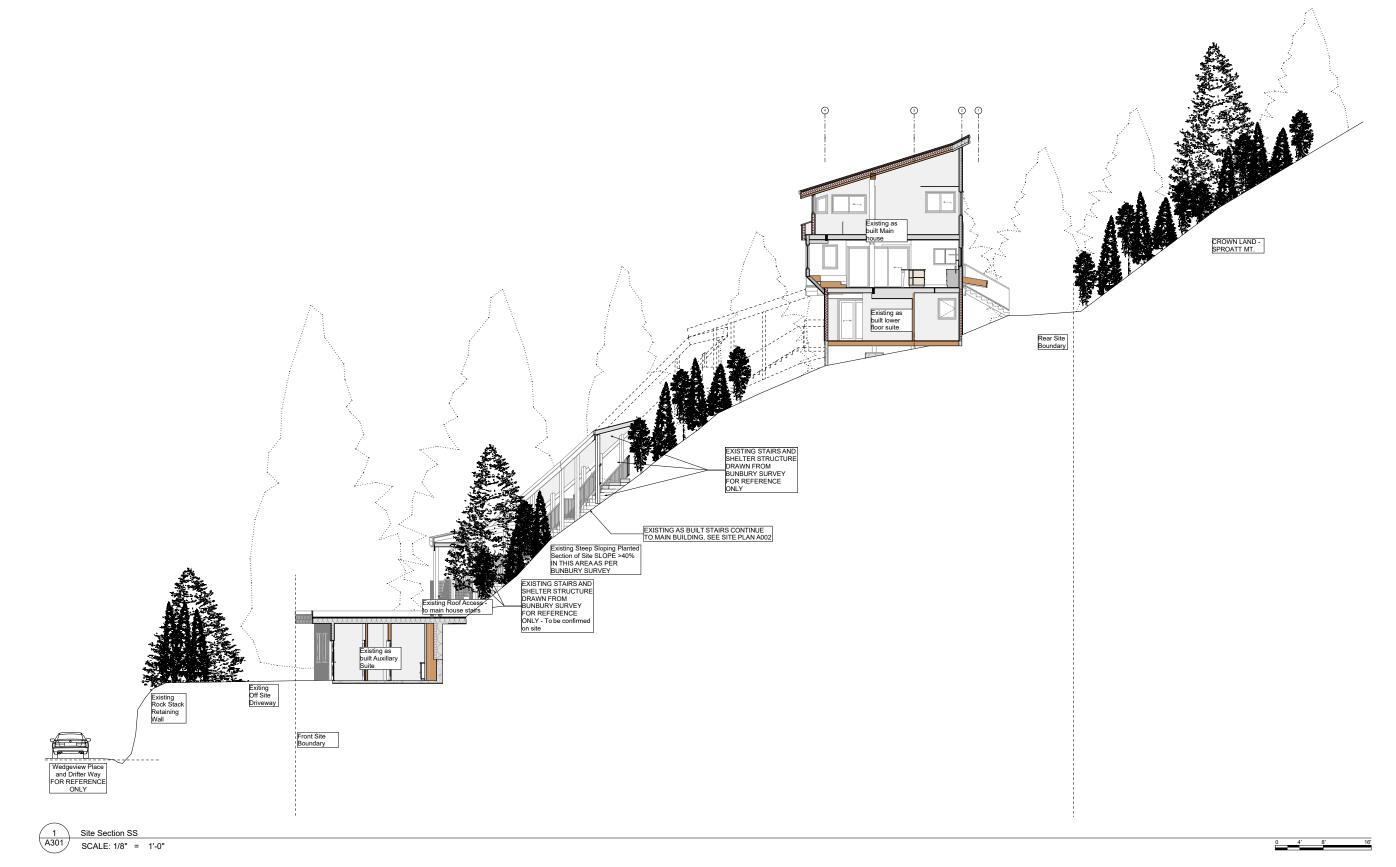
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2025-09-10

SHEET TITLE:

Elevations Auxiliary Suite

12:31 PM





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PRIME CONTRACTOR: **Coastal Mountain**

Custom Homes Ltd.

Jamie Finlayson PO Box 3265, Garibaldi Highlands, BC V0N 1T0

+1 604 764 9728

info@cmchomes.ca

STRUCTURAL ENGINEER:

Chalten Engineering

Sebastian Guerrero PO Box 1527, Whistler, BC, V0N 1B0 +1 604 902 1404

chaltenengineering@shaw.ca www.chalten.ca

CODE CONSULTANT:

Evolution Building Science Ltd. 321 East 9th St, North Vancouver, BC V7L 2B3 +1 604 318 3489 ebsl@shaw.ca Geoff Triggs

SURVEY:

Bunbury & Associates Land Surveying Ltd.

+1 604 892 3090 jeremy@bunbury-surveys.com Jeremy Childs

CLIENT:

Tom Syer and Tamara Little

8576 Drifter Way Whistler BC V8E 0G2 tom_syer@hotmail.com

PROJECT:

H69 - 8576 Drifter Way 8576 Drifter Way Whistler BC

This Drawing Set is to be submitted as part of Development Variance Permit 1223 - DVP01223 is applied for in tandem with BP6540/6541 to bring as-built existing non-conforming construction into compliance with BCBC2024 and Zoning and Parking Bylaw 303.

Drawing size is 22"x34" Prints on 11"x17" are at 50% scale


This submission is provided for permitting purposes. For construction, refer to the Issued for Construction version of these plans and supporting documents.

#01 ISSUED FOR DEVELOPMENT VARIANCE PERMIT

2025-09-10

12:31 PM

SHEET TITLE: Site Section SS

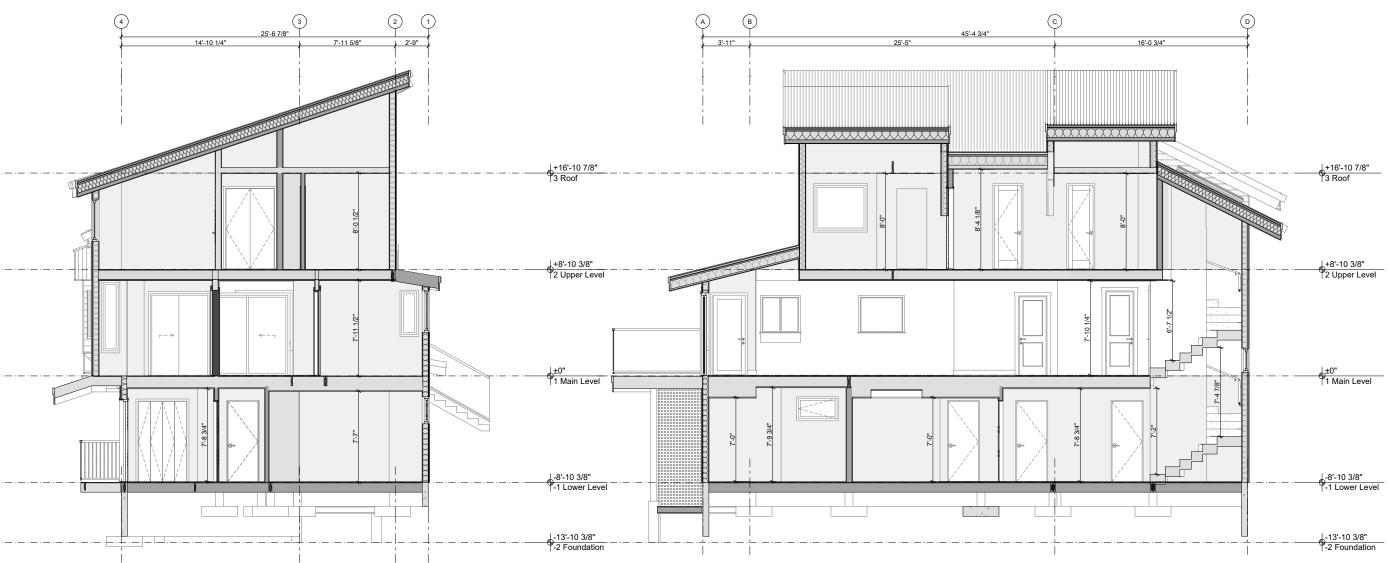

1 Section AA
A302 SCALE: 1/4" = 1'-0"

2 A302



Drawings and Specifications as instruments of service are and shall remain the property of Global Network Resource (GNAR Inc.). They are not to be used on extensions of the project, or other projects, except by agreement in writing and appropriate compensation.

The General Contractor is responsible for confirming and correlating dimensions at the job site. GNAR inc will not be responsible for construction means, methods, techniques, sequences, or procedures, or for safety precautions and programs in connection with the project.

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BIM Consultant

GNAR Inc. Edgar Dearden

BIM Consultant #206 1420 Alpha Lake Rd. Whistler

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admin@gnarinc.com www.GNARinc.com

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PROJECT: **H69 - 8576 Drifter Way** 8576 Drifter Way Whistler BC

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ISSUE:

#01 ISSUED FOR DEVELOPMENT
VARIANCE PERMIT


ISSUE:

2025-09-10

12:31 PM

SHEET TITLE:
Sections Main Dwelling

SHEET ID:

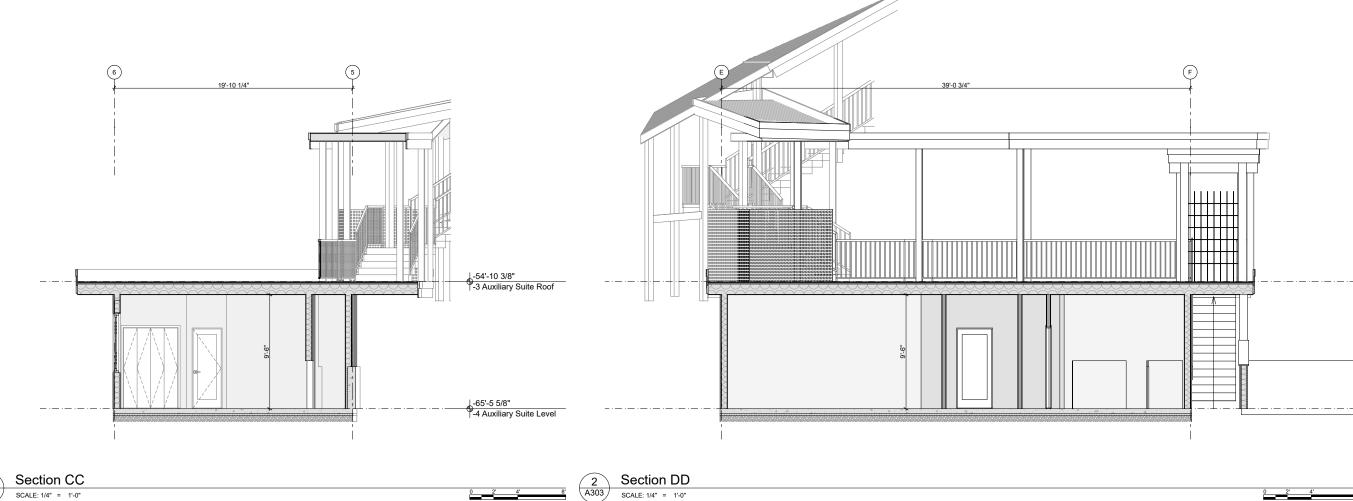



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BIM Consultant

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Edgar Dearden BIM Consultant #206 1420 Alpha Lake Rd. Whistler BC V8E 0R8

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ISSUE:

#01 ISSUED FOR DEVELOPMENT
VARIANCE PERMIT

2025-09-10

12:31 PM SHEET TITLE:

Sections Auxiliary Suite

BC LAND SURVEYOR'S SITE PLAN

ON LOT 30, DL 7251 G 1, NWD, PLAN 13066

8576 Drifter Way, Whistler, BC

(PID 008-744-653)



All distances horizontal ground—level distances in metres and decimals thereof, unless otherwise noted.

The intended plot size is 432mm in width by 280mm in height (B size) when plotted to scale.

Elevations are on CGVD28BC geodetic datum and were derived from Natural Resource Canada's PPP service using GNSS observations.

Property line dimensions are derived from Posting Plan EPP88230.

This document was prepared for mortgage and municipal/regional district purposes and is for the exclusive use of our client, Peak Ventures.

This document shows the surveyed strutures and features with respect to the boundaries of the parcel described above. This document shall not be used to define property lines or property corners.

The subject property is affected by the following non—financial charges and interests which may affect positioning of structures on the property:


Covenants: 480477M Building Scheme: 576590L

FB 2254 Pg 111
File 2021—215—3.dwg



BUNBURY & ASSOCIATES LAND SURVEYING LTD.

SQUAMISH 604-892-3090 WHISTLER 604-932-3770 WWW.BUNBURY-SURVEYS.COM

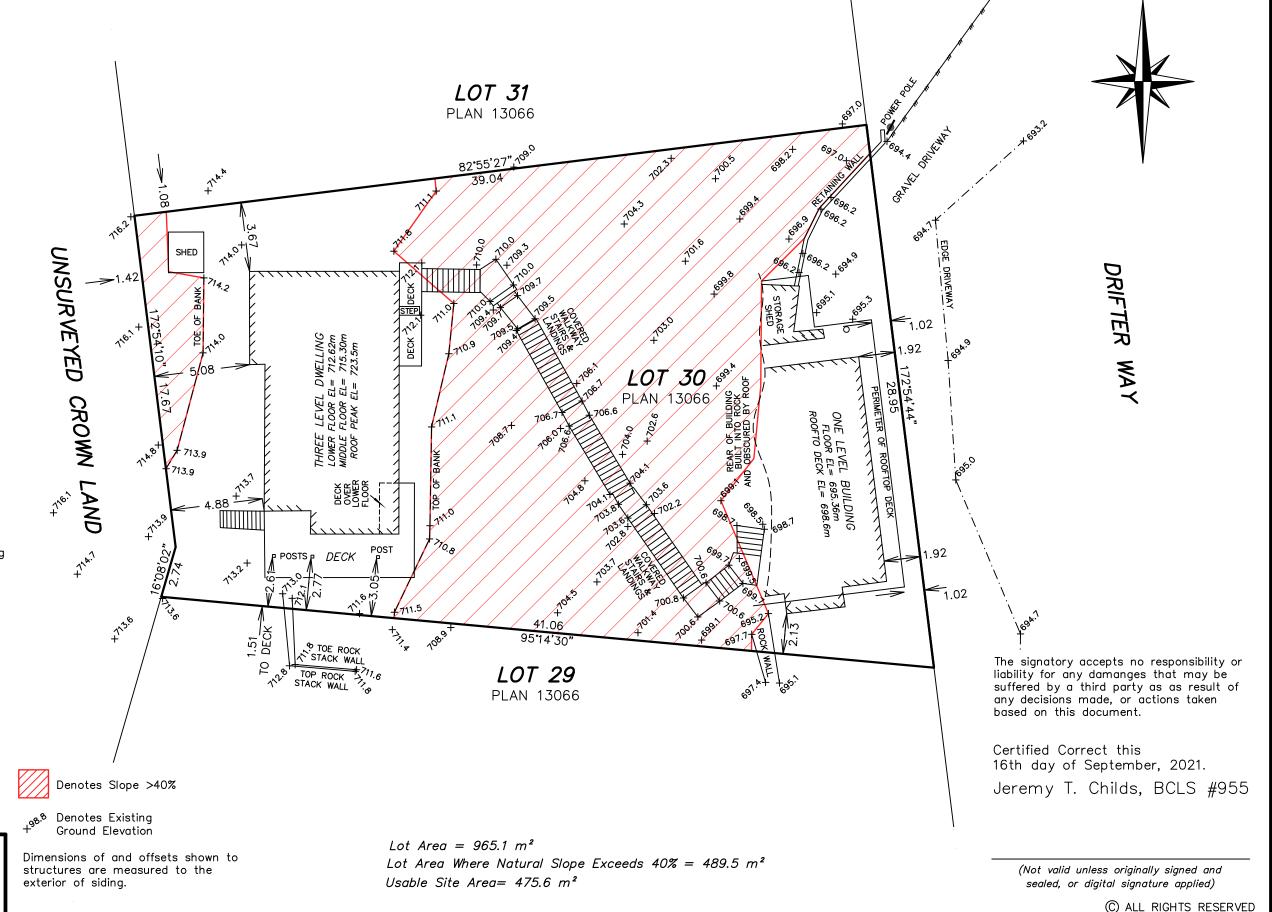

BC LAND SURVEYOR'S SITE PLAN

ON LOT 30, DL 7251 G 1, NWD, PLAN 13066

8576 Drifter Way, Whistler, BC

(PID 008-744-653)



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Covenants: 480477M **Building Scheme:**

..... Denotes Roof Eave Denotes Existing Ground Elevation


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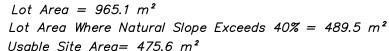
File 2021-215-7.dwg



BUNBURY & ASSOCIATES LAND SURVEYING LTD.


SQUAMISH 604-892-3090 WHISTLER 604-932-3770 WWW.BUNBURY-SURVEYS.COM



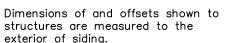

sealed, or digital signature applied)

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TITLE SEARCH PRINT 2021-10-07, 12:03:20

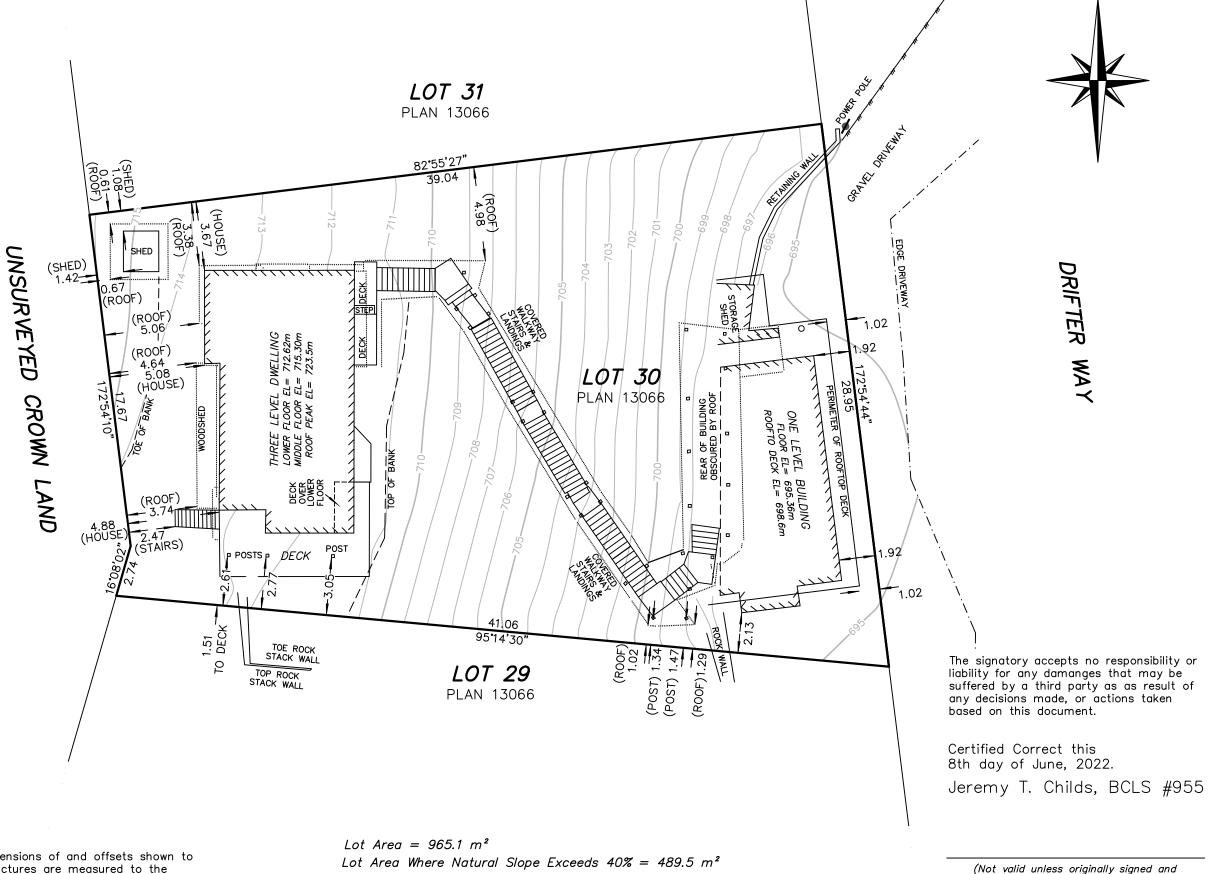Requestor:

File Reference: H69 Title DPV

Declared Value \$2080000

CURRENT INFORMATION ONLY - NO CANCELLED INFORMATION SHOWN

Land Title District VANCOUVER
Land Title Office VANCOUVER

Title Number CA7908654 From Title Number CA901847

Application Received 2019-12-04

Application Entered 2020-01-02

Registered Owner in Fee Simple

Registered Owner/Mailing Address: TOMMY MARVEN SYER,

TAMARA MAUREEN LITTLE,

AS JOINT TENANTS

Taxation Authority Whistler, Resort Municipality of

Description of Land

Parcel Identifier: 008-744-653

Legal Description:

LOT 30 DISTRICT LOT 7251 PLAN 13066

Legal Notations

LAND HEREIN WITHIN BUILDING SCHEME, SEE 576590L

SUBJECT TO PROVISOS, SEE CROWN GRANT 573998L

Charges, Liens and Interests

Nature: RESTRICTIVE COVENANT

Registration Number: 480477M

Registration Date and Time: 1968-12-05 13:36 Remarks: INTER ALIA SEE 581400L

Nature: MORTGAGE
Registration Number: CA7908655
Registration Date and Time: 2019-12-04 11:12
Registered Owner: HSBC BANK CANADA

TITLE SEARCH PRINT 2021-10-07, 12:03:20

Requestor:

File Reference: H69 Title DPV

Declared Value \$2080000

Duplicate Indefeasible Title NONE OUTSTANDING

Transfers NONE

Pending Applications NONE